


KEY PLAN

1"=500'



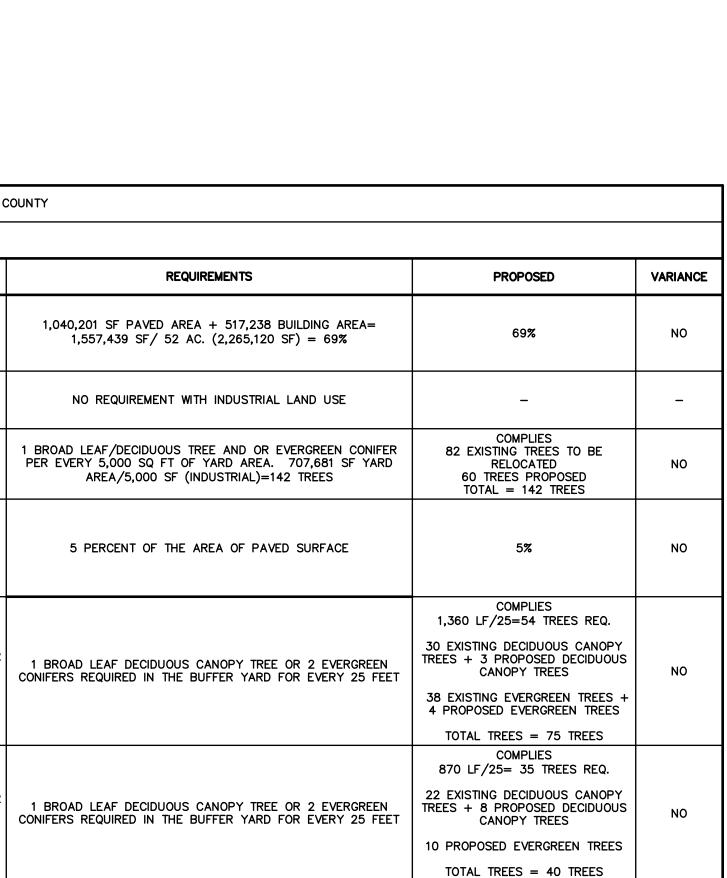

GRAPHIC SCALE

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SCALE IN FEET


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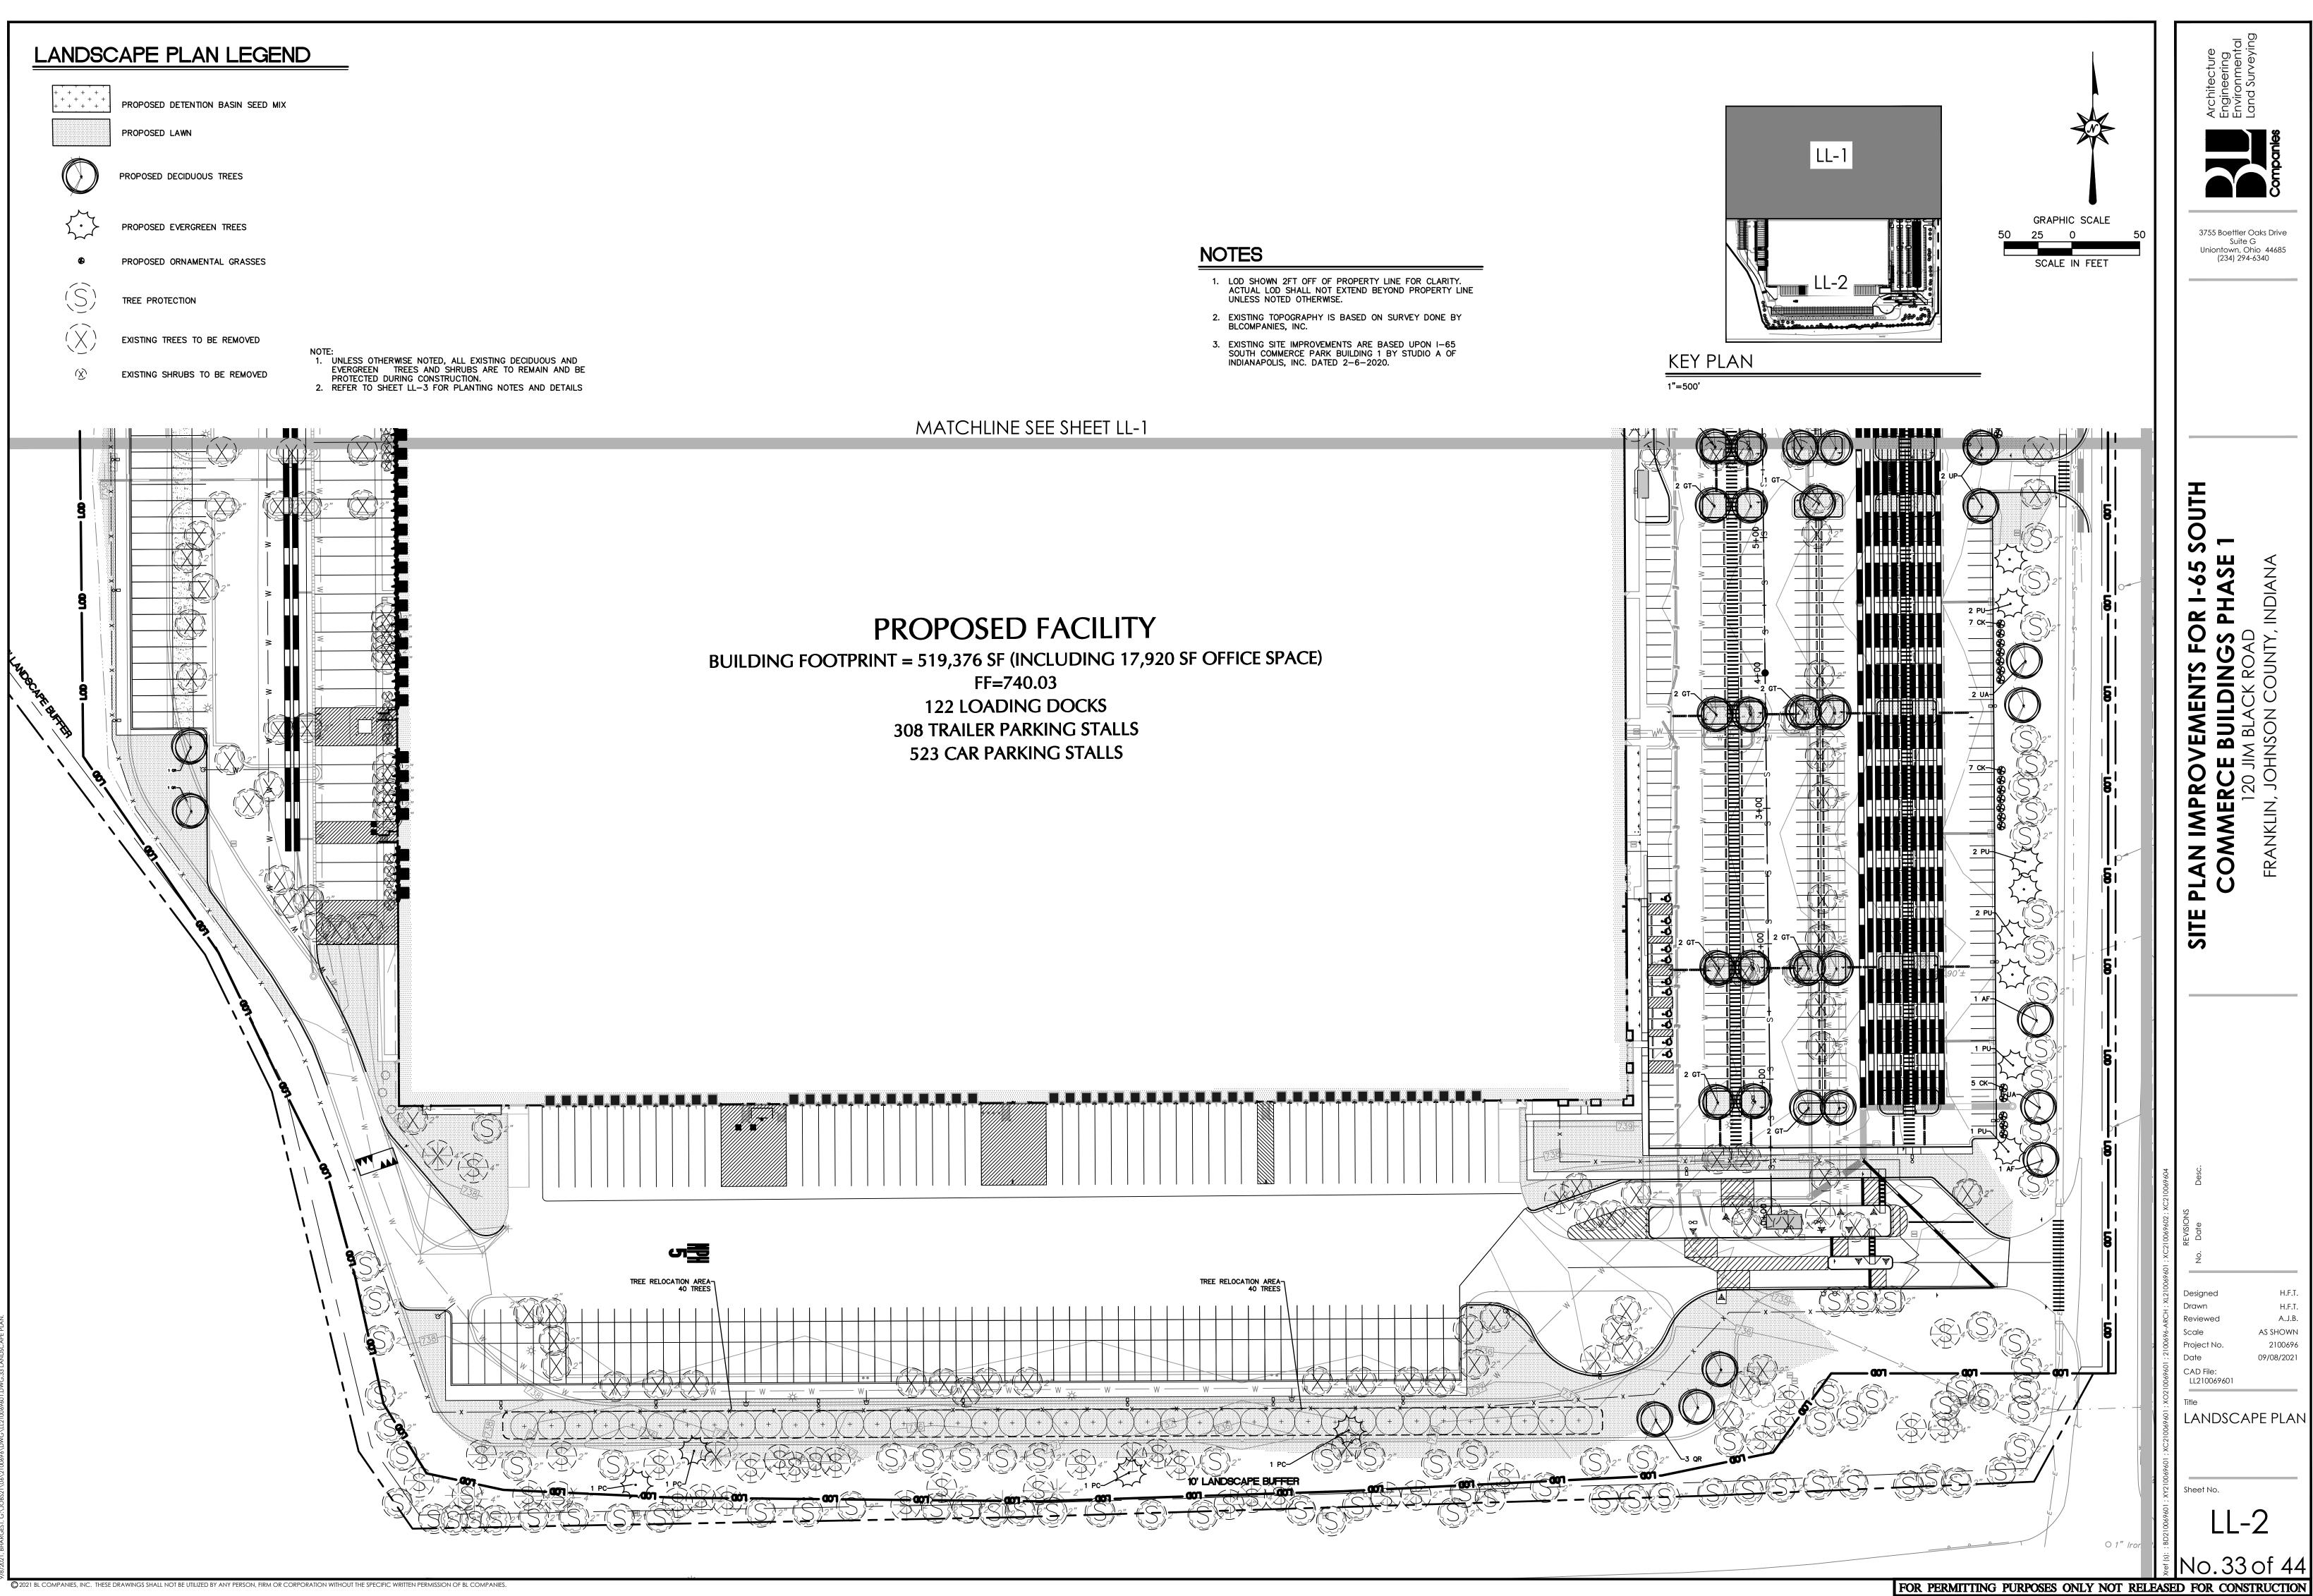
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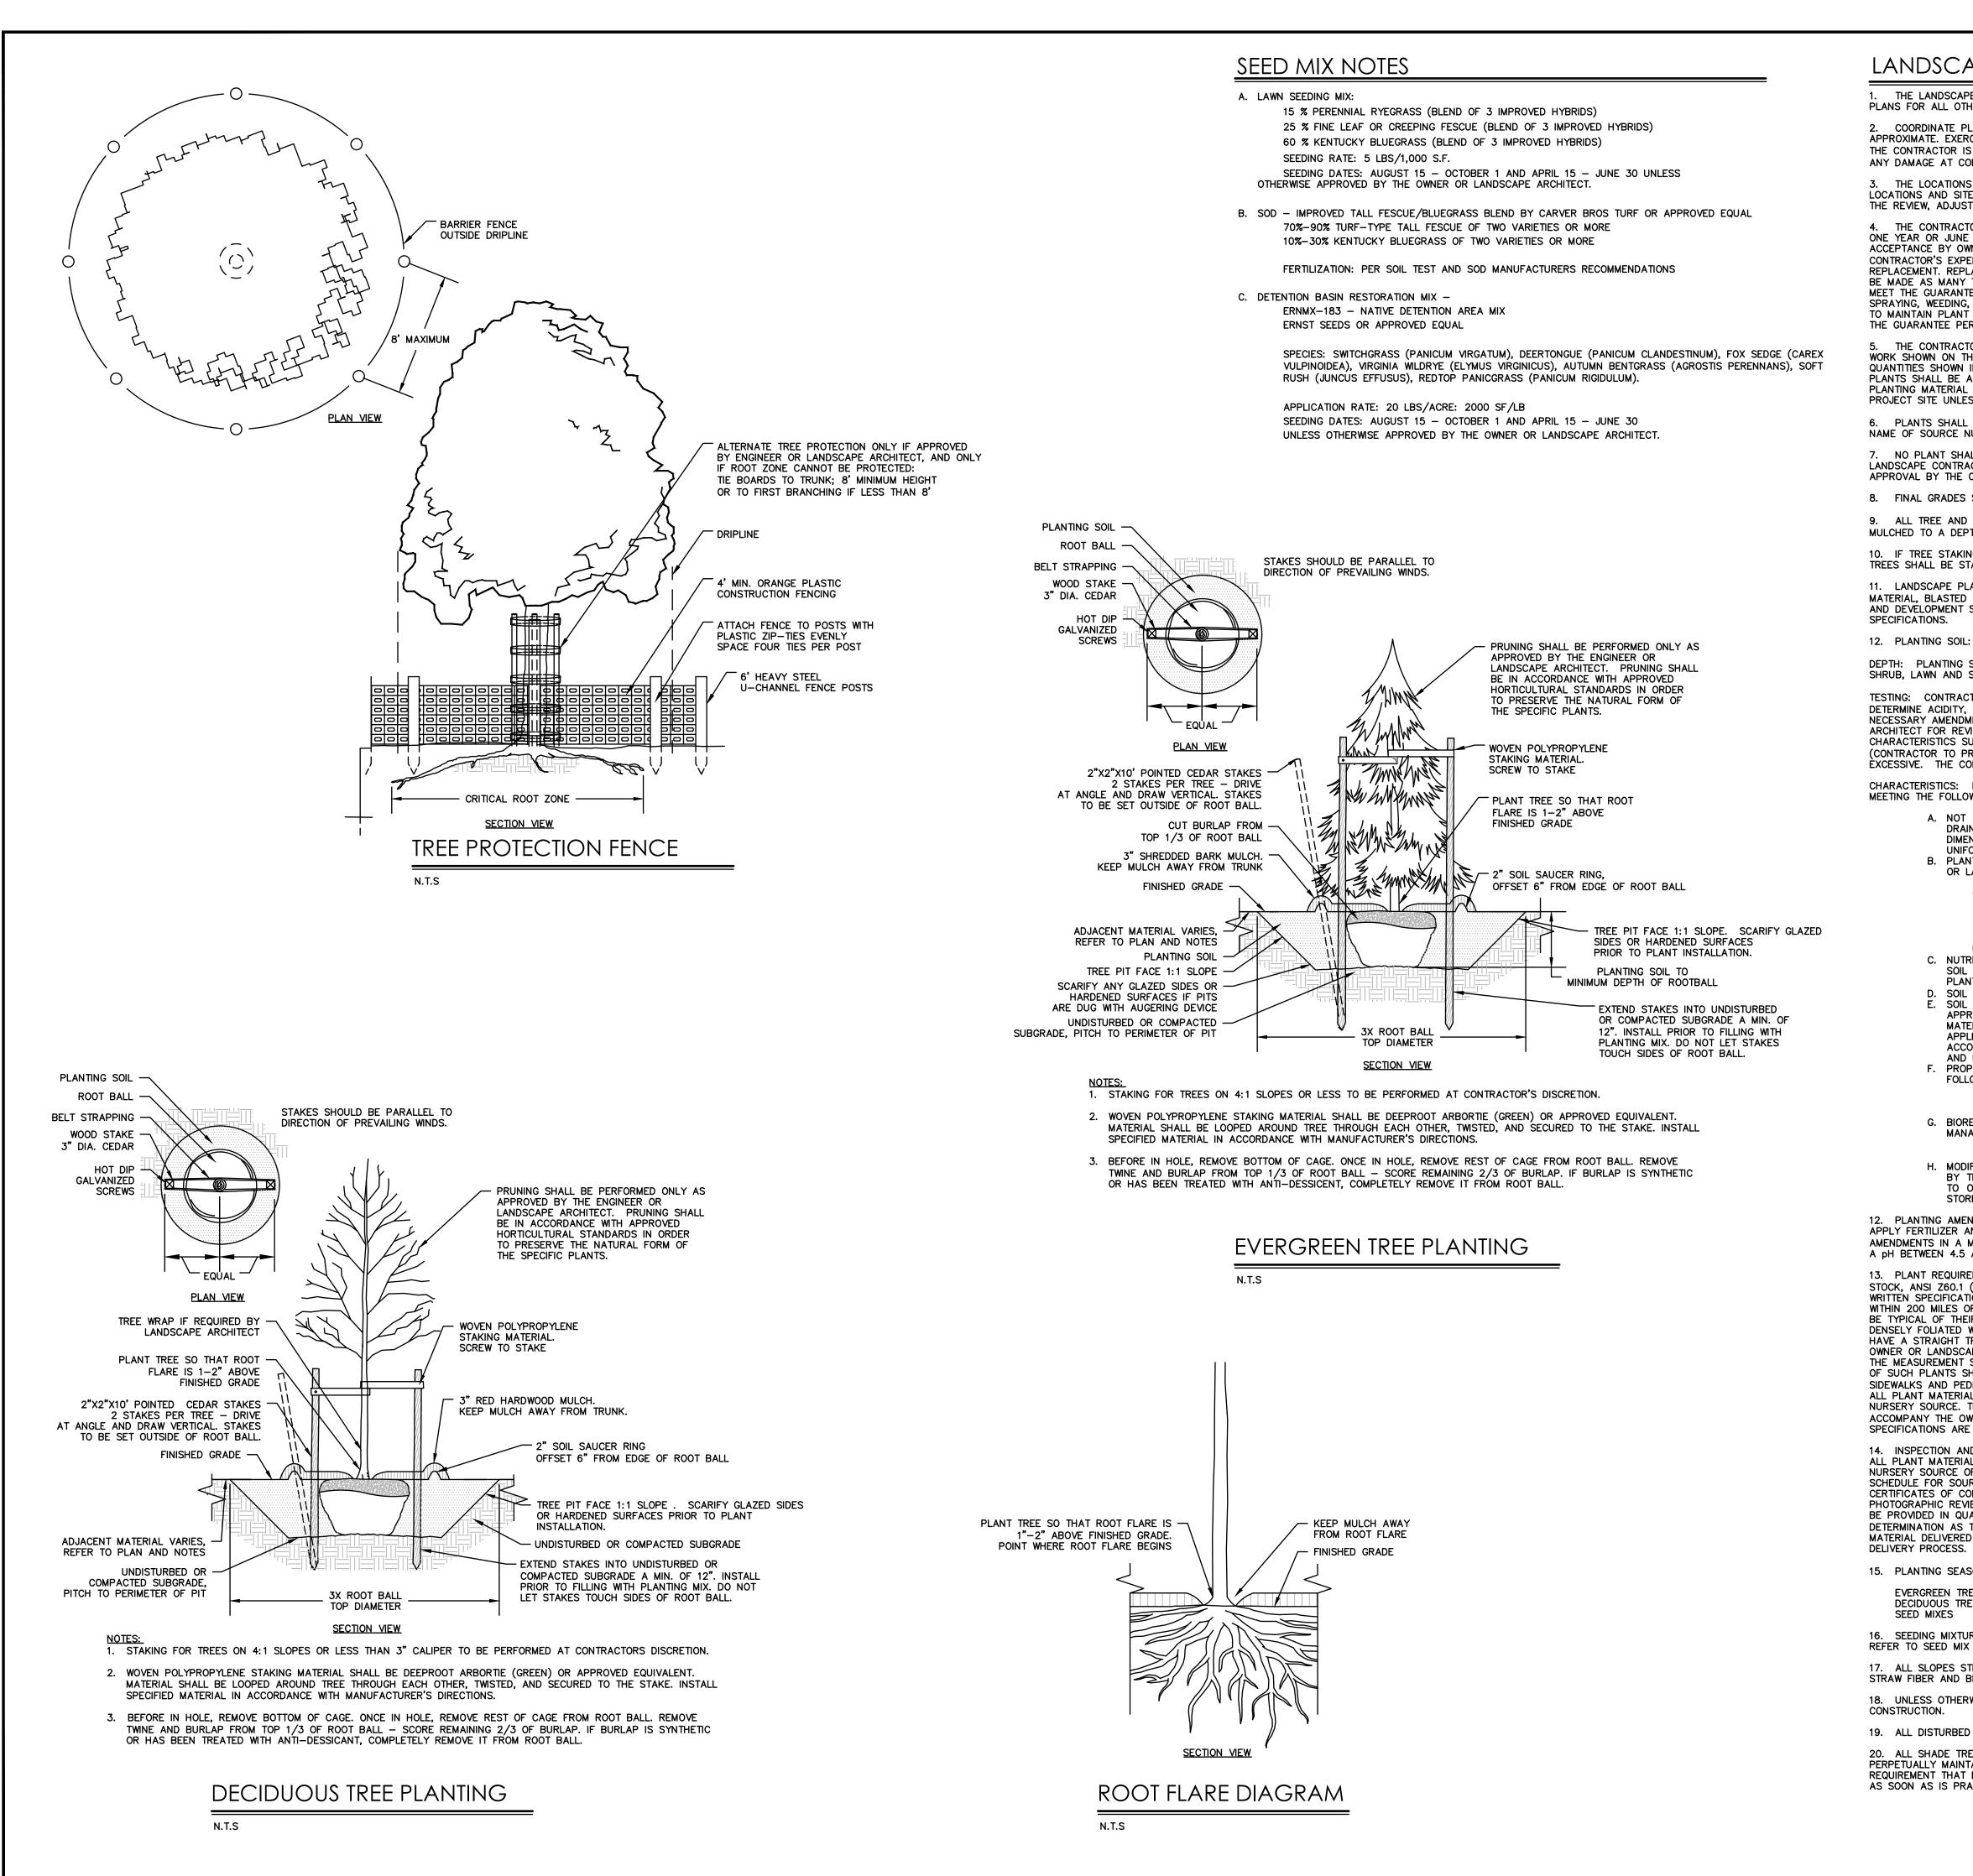
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H.F.T. Designed H.F.T. Drawn A.J.B. Reviewed AS SHOWN Scale Project No. 2100696 09/08/2021 Date CAD File: LL210069601 Title existing LANDSCAPE PLAN Sheet No. LL-O

. 31 of 44 FOR PERMITTING PURPOSES ONLY NOT RELEASED FOR CONSTRUCTION





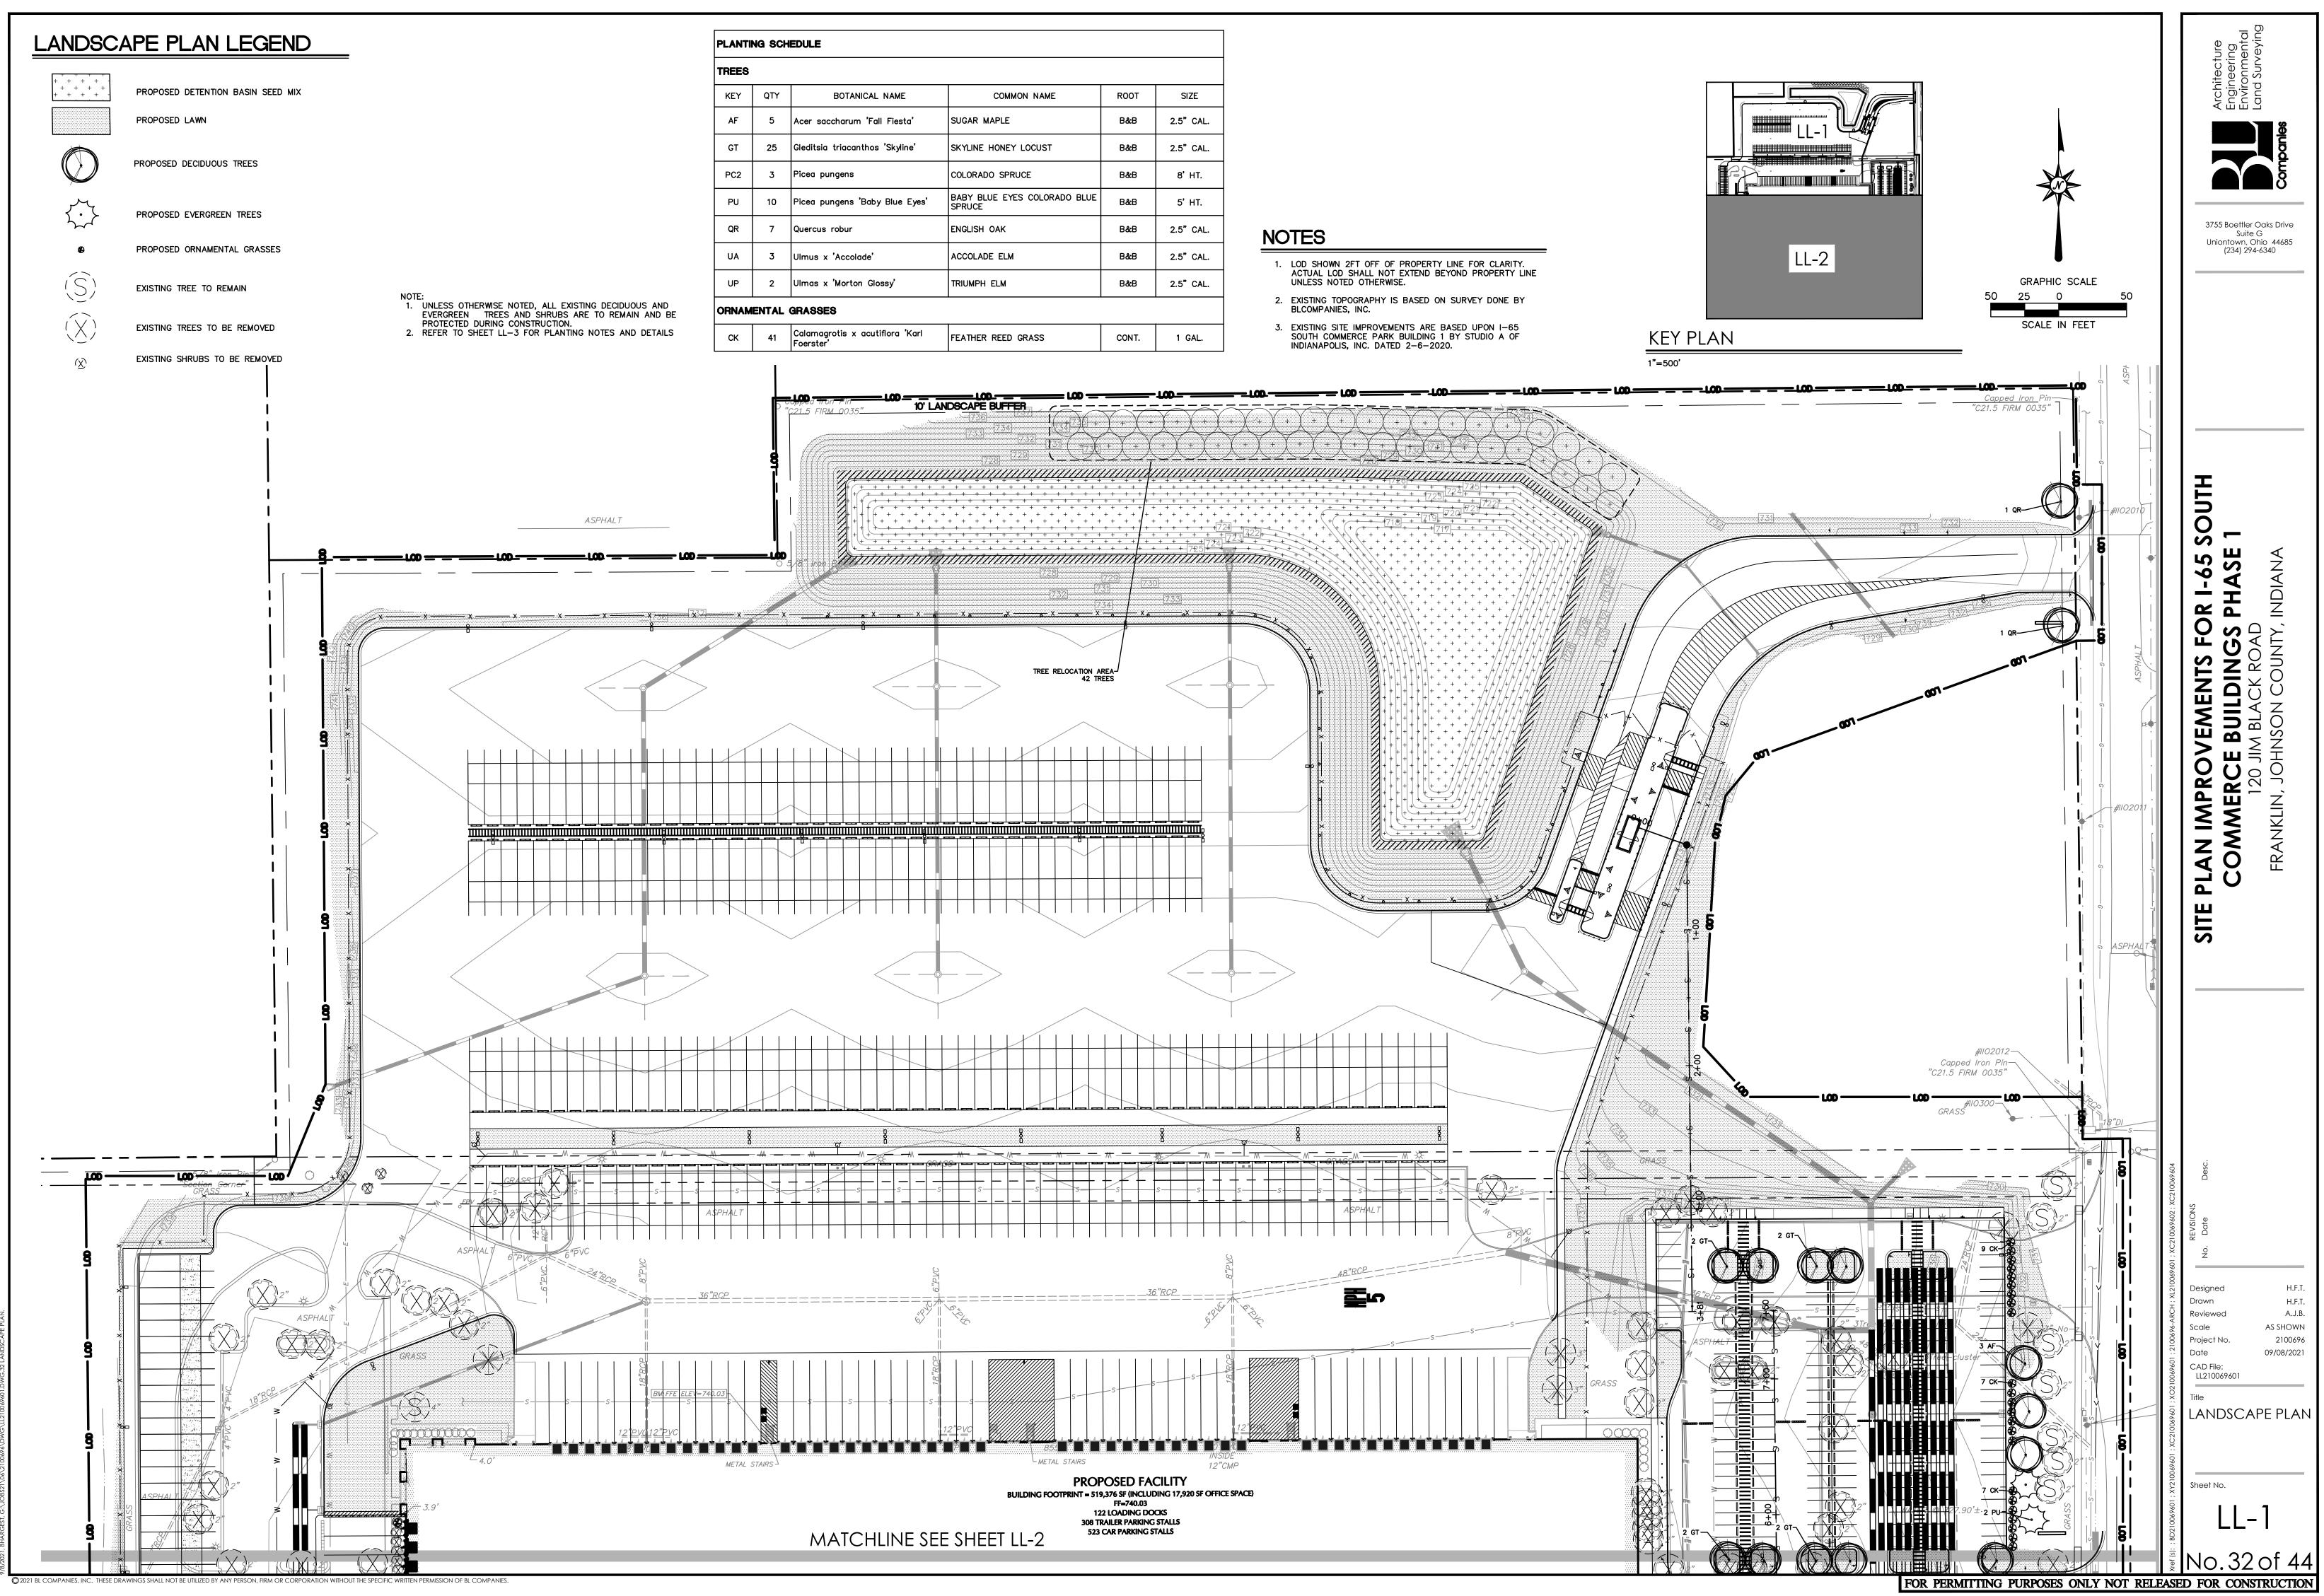

LANDSCAPE NOTES

THE LANDSCAPE PLAN AND DETAIL SHEET ARE FOR LANDSCAPING INFORMATION ONLY. PLEASE REFER TO THE OTHER PLANS FOR ALL OTHER INFORMATION.

2. COORDINATE PLANT MATERIAL LOCATIONS WITH SITE UTILITIES. UTILITY LOCATIONS SHOWN ON THE DRAWINGS ARE APPROXIMATE. EXERCISE CARE WHEN DIGGING IN AREAS OF POTENTIAL CONFLICT WITH UNDERGROUND OR OVERHEAD UTILITIES. THE CONTRACTOR IS RESPONSIBLE FOR ANY DAMAGE DUE TO CONTRACTOR'S NEGLIGENCE AND SHALL REPLACE OR REPAIR ANY DAMAGE AT CONTRACTOR'S EXPENSE.

THE LOCATIONS FOR PLANT MATERIAL ARE APPROXIMATE AND ARE SUBJECT TO FIELD ADJUSTMENT DUE TO UTILITY LOCATIONS AND SITE CONDITIONS. THE CONTRACTOR SHALL ACCURATELY STAKE OUT THE LOCATIONS FOR ALL PLANTS FOR THE REVIEW, ADJUSTMENT, AND APPROVAL OF OWNER OR LANDSCAPE ARCHITECT PRIOR TO PLANTING.

4. THE CONTRACTOR SHALL GUARANTEE THAT ALL PLANTS SHALL BE HEALTHY AND FREE OF DISEASE FOR A PERIOD OF ONE YEAR OR JUNE 1ST OF THE YEAR FOLLOWING INSTALLATION, WHICHEVER IS LONGER, AFTER SUBSTANTIAL COMPLETION AND ACCEPTANCE BY OWNER OR LANDSCAPE ARCHITECT. CONTRACTOR SHALL REPLACE ANY DEAD OR UNHEALTHY PLANTS AT CONTRACTOR'S EXPENSE. PLANT MATERIAL REPLACEMENTS SHALL BE GUARANTEED FOR ONE FULL YEAR FROM DATE OF REPLACEMENT. REPLACEMENT PLANTS SHALL BE THE SAME AS SPECIFIED FOR THE ORIGINAL PLANTING. REPLACEMENTS SHALL BE MADE AS MANY TIMES AS NECESSARY TO ENSURE HEALTHY PLANTS. FINAL ACCEPTANCE SHALL BE MADE IF ALL PLANTS MEET THE GUARANTEE REQUIREMENTS INCLUDING MAINTENANCE. MAINTENANCE RESPONSIBILITIES INCLUDE CULTIVATING, SPRAYING, WEEDING, WATERING, TIGHTENING GUYS, PRUNING, FERTILIZING, MULCHING, AND ANY OTHER OPERATIONS NECESSARY TO MAINTAIN PLANT VIABILITY, MAINTENANCE SHALL BEGIN IMMEDIATELY AFTER PLANTING AND CONTINUE UNTIL THE END OF THE GUARANTEE PERIOD.

5. THE CONTRACTOR SHALL SUPPLY ALL LABOR, PLANTS, AND MATERIALS IN QUANTITIES SUFFICIENT TO COMPLETE THE WORK SHOWN ON THE DRAWINGS AND LISTED IN THE PLANT SCHEDULE. IN THE EVENT OF A DISCREPANCY BETWEEN QUANTITIES SHOWN IN THE PLANT SCHEDULE AND THOSE REQUIRED BY THE DRAWINGS, THE LARGER SHALL APPLY. ALL PLANTS SHALL BE ACCLIMATED BY THE SUPPLY NURSERY TO THE LOCAL HARDINESS ZONE AND BE CERTIFIED THAT THE PLANTING MATERIAL HAS BEEN GROWN FOR A MINIMUM OF TWO YEARS AT THE SOURCE AND OBTAINED WITHIN 200 MILES OF PROJECT SITE UNLESS OTHERWISE APPROVED BY OWNER OR LANDSCAPE ARCHITECT.

6. PLANTS SHALL HAVE TAGS THAT IDENTIFY PLANT GENUS, SPECIES, CULTIVAR (IF APPLICABLE), PLANT COMMON NAME, NAME OF SOURCE NURSERY, AND SIZE OF PLANT FOR REVIEW OF OWNER OR LANDSCAPE ARCHITECT.

7. NO PLANT SHALL BE PLACED IN THE GROUND BEFORE ROUGH GRADING HAS BEEN COMPLETED AND APPROVED BY LANDSCAPE CONTRACTOR. STAKING THE LOCATION OF ALL TREES AND SHRUBS SHALL BE COMPLETED PRIOR TO PLANTING FOR APPROVAL BY THE OWNER OR LANDSCAPE ARCHITECT.

8. FINAL GRADES SHALL BLEND SMOOTHLY WITH EXISTING, AND TOP AND BOTTOM OF SLOPES SHALL BE ROUNDED.

9. ALL TREE AND SHRUB MASSINGS SHALL BE MULCHED TO A DEPTH OF 3". ANNUAL AND PERENNIAL BEDS SHALL BE MULCHED TO A DEPTH OF 2". MULCH SHALL BE RED HARDWOOD MULCH, AGED AT LEAST 6 MONTHS.

10. IF TREE STAKING IS PROPOSED, TREE STAKING MUST BE COMPLETED THE SAME DAY AS THE TREE IS INSTALLED. ALL TREES SHALL BE STAKED OR GUYED PER DETAIL.

11. LANDSCAPE PLANTING AREAS MUST BE FREE DRAINING. PAVEMENT, COMPACTED SUBGRADE, DEAD OR DYING PLANT MATERIAL, BLASTED ROCK, STONES GREATER THAN 1" IN DIAMETER, AND ANY OTHER MATERIAL HARMFUL TO PLANT GROWTH AND DEVELOPMENT SHALL BE REMOVED FROM AREAS TO BE LANDSCAPED AS REQUIRED BY PLANTING DETAILS OR SPECIFICATIONS.

12. PLANTING SOIL:

DEPTH: PLANTING SOIL SHALL BE INSTALLED AT A MINIMUM DEPTH OF 4". PLANTING SOIL SHALL BE INSTALLED IN ALL TREE. SHRUB, LAWN AND SEEDED PLANTING AREAS.

TESTING: CONTRACTOR SHALL SUBMIT (2) SOIL SAMPLES PER SOIL STOCKPILE TO A CERTIFIED TESTING LABORATORY TO DETERMINE ACIDITY, ORGANIC CONTENT, MECHANICAL ANALYSIS, AVAILABLE NUTRIENTS (N,P,K,Ca,Mg,S,Fe,Mn,Zn,Cu,B,AI,Pb) AND NECESSARY AMENDMENTS TO SOIL. THE CONTRACTOR SHALL SUBMIT THE TEST RESULTS TO THE OWNER OR LANDSCAPE ARCHITECT FOR REVIEW AND APPROVAL. TEST RESULTS SHALL RECOMMEND AMENDMENTS THAT WILL ALTER THE SOIL CHARACTERISTICS SUCH THAT THE CHARACTERISTICS DESCRIBED BELOW ARE ACHIEVED AND THE SPECIFIED PLANTS (CONTRACTOR TO PROVIDE LIST TO TESTING LABORATORY) WILL ACHIEVE PROPER GROWTH THAT IS NEITHER DEFICIENT NOR

ÈXCESSIVE. THE CONTRACTOR SHALL INCORPORATE THESE AMENDMENTS AT NO INCREASE IN CONTRACT PRICE. CHARACTERISTICS: PLANTING SOIL MAY CONSIST OF EXISTING ON-SITE SOILS, AMENDED ON-SITE SOILS, OR IMPORTED SOILS MEETING THE FOLLOWING CRITERIA:

- A. NOT TO CONTAIN MATERIALS HARMFUL TO PLANT LIFE, TO BE CLEAN, FERTILE, FRIABLE, AND WELL DRAINING. ALL PLANTING SOIL SHALL BE FREE OF ANY SUBSOIL EARTH CLODS, SODS, STONES OVER 1" IN ANY DIMENSION, STICKS, ROOTS, WEEDS, LITTER AND OTHER DELETERIOUS MATERIAL. PLANTING SOIL SHALL BE UNIFORM IN QUALITY AND TEXTURE.
- B. PLANTING SOIL SHALL HAVE THE FOLLOWING OPTIMUM RANGES UNLESS OTHERWISE APPROVED BY THE OWNER OR LANDSCAPE ARCHITECT. ORGANIC CONTENT 3% – 6% FOR LAWN OR GRASS AREAS.

4% - 8% FOR TREE AND SHRUB PLANTERS 8%-16% FOR RETENTION OR DETENTION BASINS

(BY LOSS OF IGNITION AT 375 C METHOD OF TESTING)

- 6.0 7.3 NUTRIENT LEVELS SHALL BE ACHIEVED BY THE CONTRACTOR'S ADDITION OF AMENDMENTS TO THE PLANTING SOIL TO MEET THE OPTIMUM NUTRIENT LEVELS SPECIFIED IN THE TESTING LABORATORY REPORT FOR EACH OF PLANTS TO BE INSTALLED.
- . SOIL SHALL BE COMPACTED TO A SURFACE PENETRATION RESISTANCE OF 75-125 LBS/SQ.IN. E. SOIL MAY BE TREATED FOR WEEDS WITH PRE-EMERGENT OR POST-EMERGENT HERBICIDE, AS NEEDED AND AS APPROPRIATE FOR THE APPLICATION SEASON OR LOCATION, OR ELIMINATE GROWTH OF UNWANTED PLANT MATERIAL. APPLY HERBICIDES IN ACCORDANCE WITH MANUFACTURERS RECOMMENDATIONS. HERBICIDE APPLICATOR MUST BE LICENSED IN THE STATE OF NORTH CAROLINA, AND PERFORM APPLICATIONS IN ACCORDANCE WITH LOCAL REQUIREMENTS, PERMITTING STIPULATIONS, AND ANY OTHER RESTRICTIONS INCLUDING AND IN EXCESS OF STATE AND FEDERAL REGULATIONS. PROPOSED TOPSOIL SHALL MEET THE USDA SOILS TEXTURAL PERCENTAGES OF SAND, SILT, AND CLAY FOR
- FOLLOWING CLASSIFICATIONS: – LOAM - SANDY LOAM WHERE SAND DOES NOT EXCEED 70% AND CLAY IS NOT LESS THAN 5%.
- SANDY CLAY LOAM WHERE SAND DOES NOT EXCEED 70% AND CLAY IS LESS THAN 28%. G. BIORETENTION SOILS: SOIL TO BE INSTALLED IN RETENTION BASINS. PONDS. OR OTHER STORMWATER MANAGEMENT ENVIRONS SHALL MEET THE ABOVE DESRCIBED CHARACTERISTICS AND AS FOLLOWS: - SOIL SHALL NOT CONTAIN MORE THAN 20% CLAY AND LESS THAN 40% SILT.
- SOIL SHALL HAVE AN INFILTRATION RATE BETWEEN 1/2" AND 3" PER HOUR. I. MODIFICATION TO THE PLANTING SOIL CHARACTERISTICS DESCRIBED ABOVE MAY BE SUBMITTED FOR APPROVAL BY THE LANDSCAPE ARCHITECT. CONTRACTOR MUST DEMONSTRATE PROPOSED CHARACTERISTICS ARE EQUAL TO OR SUPERIOR TO THE SPECIFIED CHARACTERISTICS WITH RESPECT TO SUPPORTING PLANT GROWTH, AND STORMWATER MANAGEMENT.

12. PLANTING AMENDMENTS: APPLY FERTILIZER AND OTHER AMENDMENTS AS RECOMMENDED FOR EACH PLANTING AREA BY SOIL ANALYSIS. APPLY AMENDMENTS IN A MANNER CONSISTENT WITH MANUFACTURER'S RECOMMENDATIONS. ANY ORGANIC AMENDMENTS SHALL HAVE A pH BETWEEN 4.5 AND 5.5 UNLESS OTHERWISE RECOMMENDED.

13. PLANT REQUIREMENTS: ALL PLANTS SHALL CONFORM IN SIZE AND GRADE TO THE AMERICAN STANDARD FOR NURSERY STOCK, ANSI Z60.1 (LATEST EDITION). ALL PLANTS SHALL MEET THE ADDITIONAL REQUIREMENTS SET FORTH BELOW AND IN WRITTEN SPECIFICATIONS AS APPLICABLE. ALL TREES AND SHRUBS SHALL HAVE BEEN GROWN AT A COMMERCIAL NURSERY WITHIN 200 MILES OF THE PROJECT SITE UNLESS OTHERWISE APPROVED BY OWNER OR LANDSCAPE ARCHITECT. THEY SHALL BE TYPICAL OF THEIR SPECIES OR VARIETY. THEY SHALL BE HEALTHY, SYMMETRICAL, EVENLY AND DENSELY BRANCHED, AND DENSELY FOLIATED WHEN IN LEAF. THEY SHALL BE FREE OF BARK INJURY, DISEASE, AND INSECT PESTS. ALL TREES SHALL HAVE A STRAIGHT TRUNK WITH A SINGLE MAIN LEADER UNLESS OTHERWISE CHARACTERISTIC OF THE SPECIES OR VARIETY. THE OWNER OR LANDSCAPE ARCHITECT WILL ALLOW SUBSTITUTIONS ONLY UPON WRITTEN APPROVAL. SIZES SHALL CONFORM TO THE MEASUREMENT SPECIFIED ON THE DRAWINGS. PLANTS LARGER THAN SPECIFIED MAY BE USED IF APPROVED, BUT THE USE OF SUCH PLANTS SHALL NOT INCREASE THE CONTRACT PRICE. ALL OVERSTORY TREES PLANTED ALONG PARKING AREAS, SIDEWALKS AND PEDESTRIAN ACCESSES SHALL NOT BRANCH BELOW 7' FEET IF THE TREE CALIPER IS 3" INCHES OR GREATER. ALL PLANT MATERIALS ARE SUBJECT TO INSPECTION AND ACCEPTANCE BY THE OWNER OR LANDSCAPE ARCHITECT AT THE NURSERY SOURCE. THE CONTRACTOR SHALL COORDINATE SOURCE VISITS WITH THE LANDSCAPE ARCHITECT AND SHALL ACCOMPANY THE OWNER AND/OR LANDSCAPE ARCHITECT FOR ALL INSPECTIONS. CERTIFICATES OF COMPLIANCE WITH SPECIFICATIONS ARE REQUIRED FOR ALL PLANTS.

14. INSPECTION AND REVIEW: ALL PLANT MATERIAL SHALL BE SUBJECT TO INSPECTION AND ACCEPTANCE BY THE OWNER OR LANDSCAPE ARCHITECT AT THE NURSERY SOURCE OR PLACE OF GROWTH. THE CONTRACTOR SHALL COORDINATE WITH THE LANDSCAPE ARCHITECT ON A SCHEDULE FOR SOURCE VISITS AND ACCOMPANY THE OWNER OR LANDSCAPE ARCHITECT FOR ALL SOURCE INSPECTIONS. CERTIFICATES OF COMPLIANCE ARE REQUIRED FOR ALL PLANT MATERIALS. PHOTOGRAPHIC REVIEW OF PLANT MATERIAL IS ACCEPTABLE IF APPROVED BY LANDSCAPE ARCHITECT. PHOTOGRAPHS MUST BE PROVIDED IN QUANTITY AND VARIETY TO ALLOW LANDSCAPE ARCHITECT SUFFICIENT INFORMATION TO MAKE A REASONABLE DETERMINATION AS TO THE PLANTS' QUALITY. OWNER AND LANDSCAPE ARCHITECT RESERVES THE RIGHT TO REJECT PLANT MATERIAL DELIVERED TO THE SITE BUT PREVIOUSLY ACCEPTED IF DAMAGED OR NOT PROPERLY MAINTAINED DURING THE

15. PLANTING SEASONS (UNLESS OTHERWISE APPROVED BY THE OWNER OR LANDSCAPE ARCHITECT) <u>SPRING</u> APRIL 1 TO JUNE 15 EVERGREEN TREES AND SHRUBS SEPTEMBER 1 TO OCTOBER 15 DECIDUOUS TREES AND SHRUBS APRIL 1 TO JUNE 15 SEPTEMBER 15 TO NOVEMBER 15 PER MANUFACTURERS RECOMMENDATIONS OR AS LISTED IN SEED NOTES SEED MIXES

16. SEEDING MIXTURES: REFER TO SEED MIX NOTES. SEEDED AREA SHALL BE ACCEPTED WHEN SEED AREA ACHIEVES 90% COVERAGE. 17. ALL SLOPES STEEPER THAN 3:1 RECEIVING A SEED MIX SHALL BE COVERED WITH AN EROSION CONTROL BLANKET OF

STRAW FIBER AND BIODEGRADABLE OR PHOTODEGRADABLE NETTING. 18. UNLESS OTHERWISE NOTED IN DRAWING SET, NEW TREELINES SHALL EQUAL CLEARING AND GRUBBING LIMIT FOR CONSTRUCTION.

19. ALL DISTURBED AREAS NOT OTHERWISE DEVELOPED SHALL BE SEEDED WITH THE LAWN SEED MIX.

20. ALL SHADE TREE, BUFFER YARD AND OTHER LANDSCAPING REQUIRED BY LOCAL ORDINANCE OR ZONING SHALL BE PERPETUALLY MAINTAINED BY THE PROPERTY OWNER. ANY LANDSCAPING NEEDED TO MEET AN ORDINANCE OR ZONING REQUIREMENT THAT DIES, IS REMOVED, OR IS SEVERELY DAMAGED SHALL BE REPLACED BY THE CURRENT PROPERTY OWNER AS SOON AS IS PRACTICAL CONSIDERING GROWING SEASONS, WITH A MAXIMUM OF 150 DAYS.




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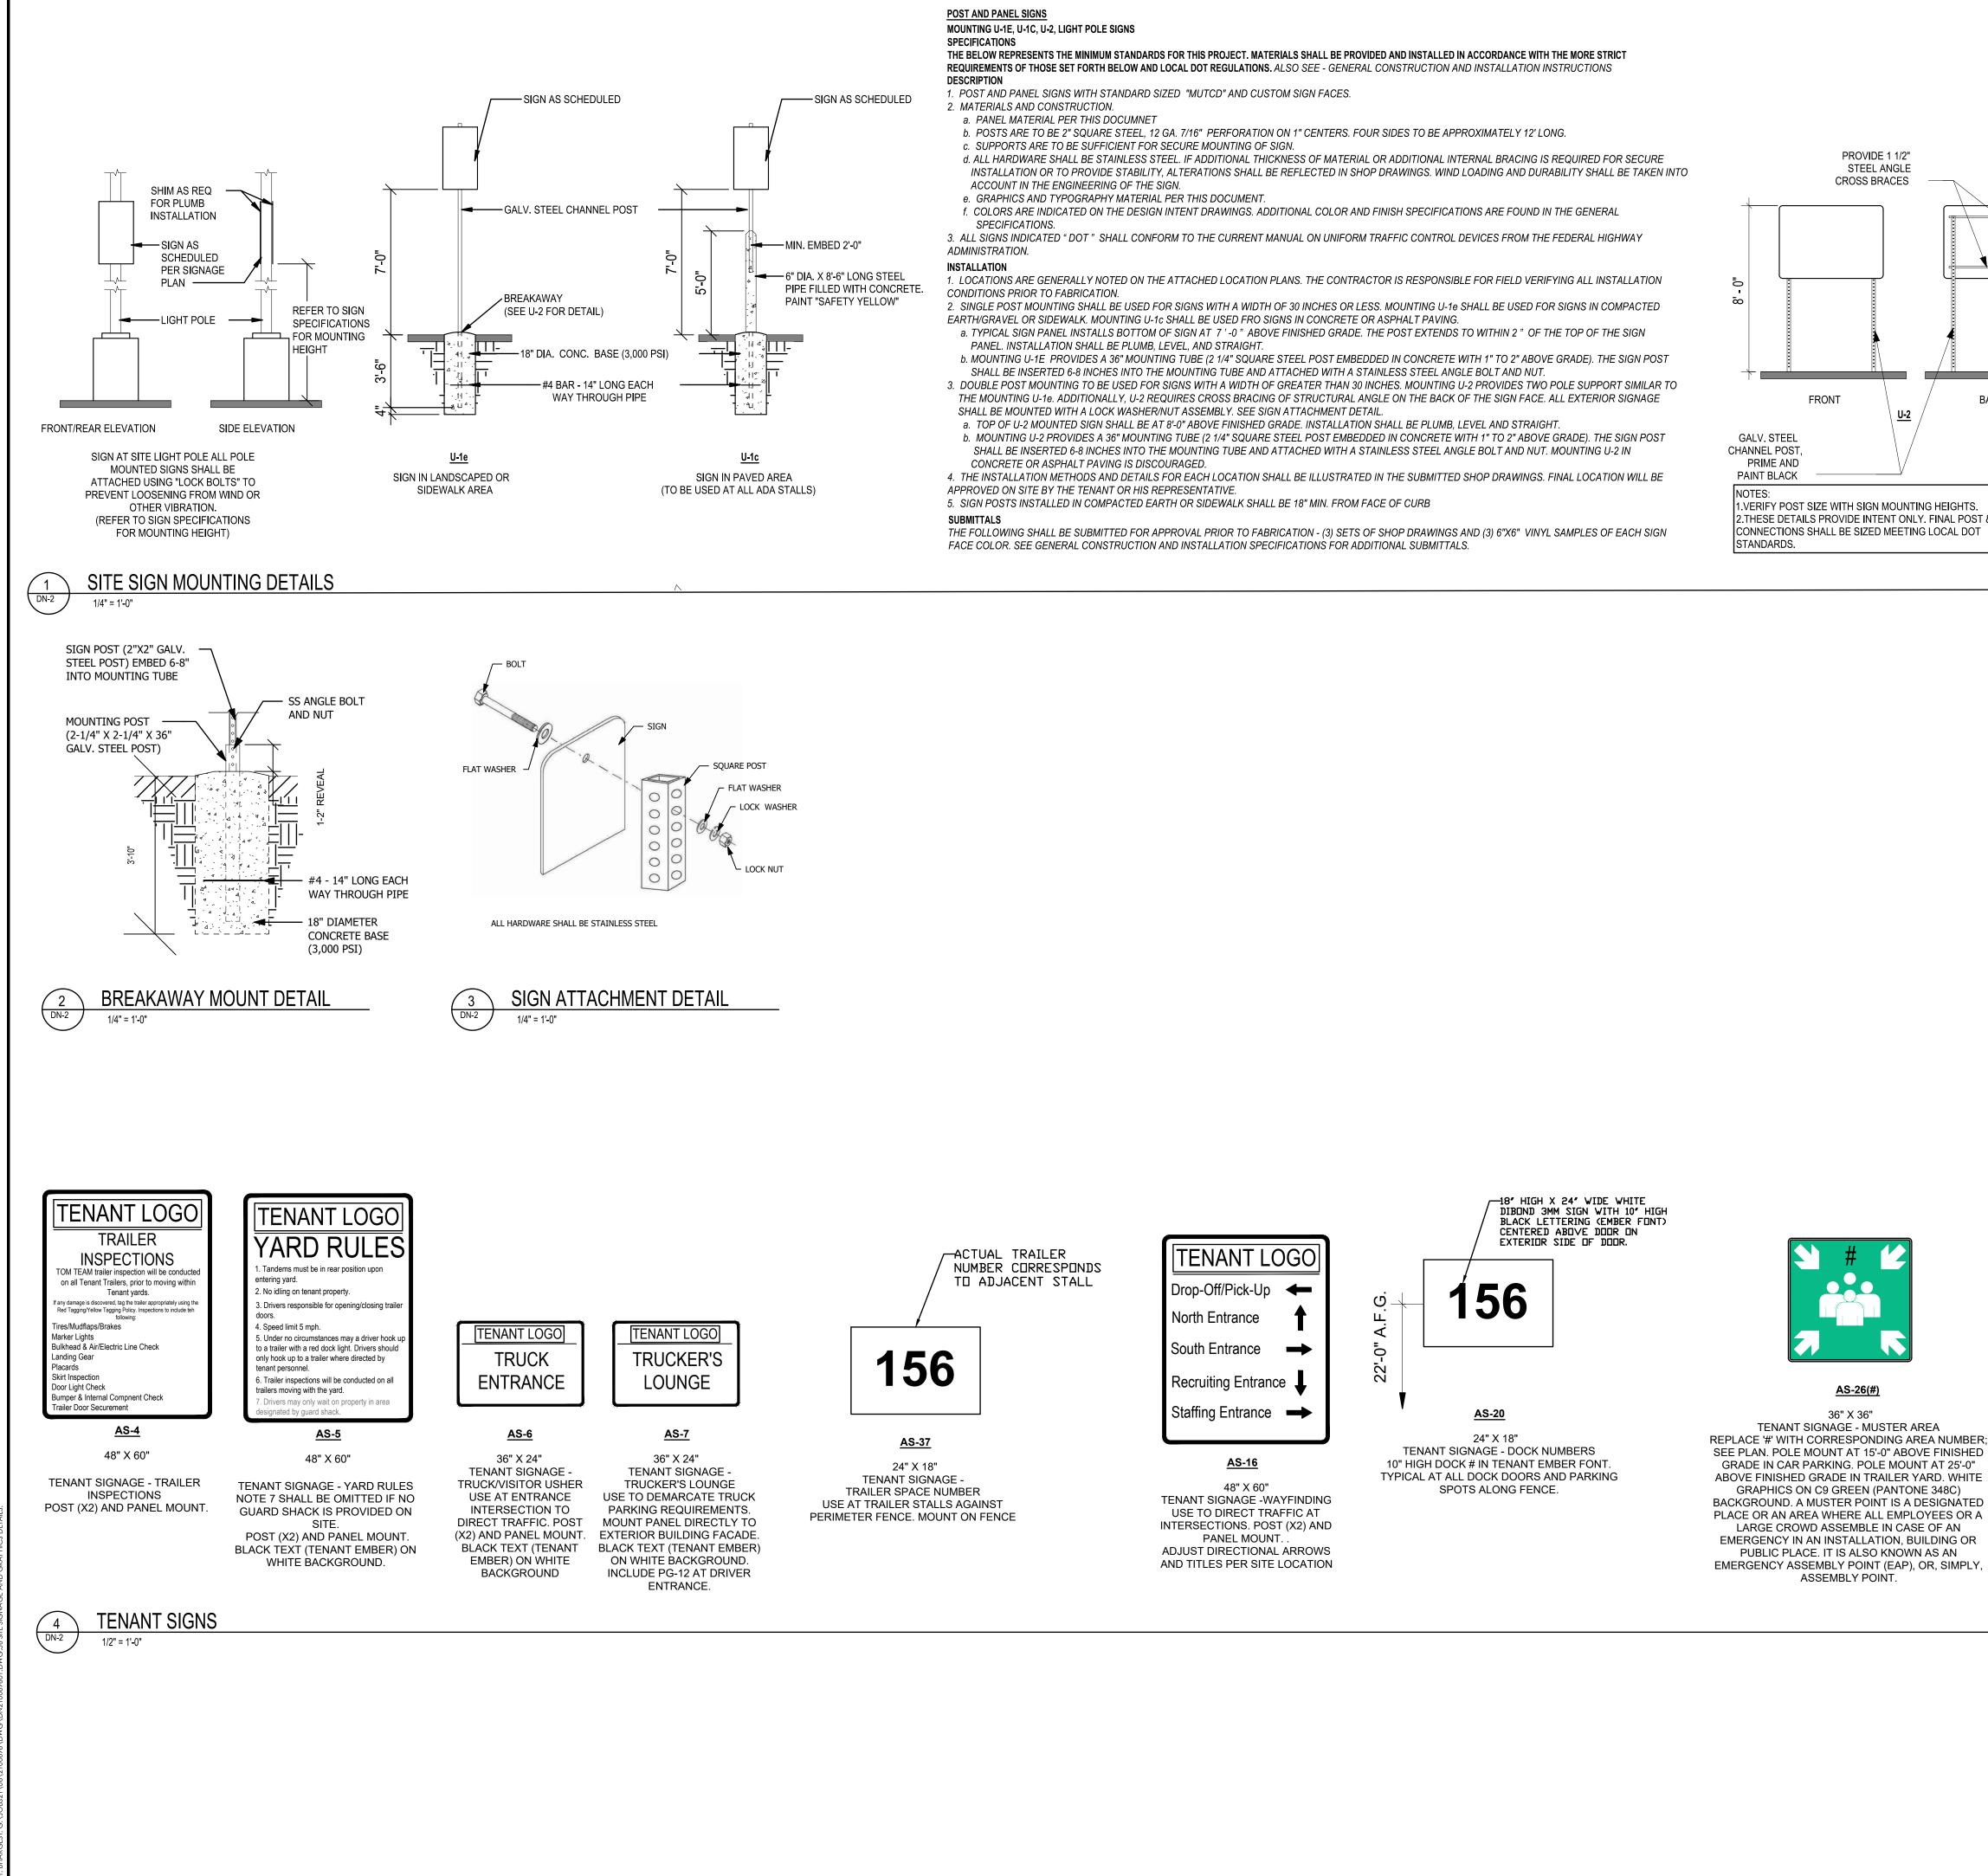



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	 NOTE: 1. STGPF N. POST N. POST N. POST N. POST N. TED 9. STREE 9. STREE 1. STREE <p< th=""><th>SITE PLAN IMPROVEMENTS FOR I-65 SOUTH COMMERCE BUILDINGS PHASE 1 120 JIM BLACK ROAD FRANKLIN, JOHNSON COUNTY, INDIANA</th></p<>	SITE PLAN IMPROVEMENTS FOR I-65 SOUTH COMMERCE BUILDINGS PHASE 1 120 JIM BLACK ROAD FRANKLIN, JOHNSON COUNTY, INDIANA
PROVIDE 24" HIGH 3 DIGIT NUMERIS MARKINGS - TYPICAL AT ALL DOCK AND TRAILER PARKING SPACES. MARKINGS TO BE DESIGNATED BY OWNER. SEE PAVEMENT GRAPHICS FOR ADDITIONAL	CONCRETE PAVEMENT IS PREVALENT. 6. ALL PROPOSED SIGNAGE AND STRIPING SHALL BE INSTALLED IN ACCORDANCE WITH THE TENANT FULFILLMENT WORLDWIDE REAL ESTATE SIGNAGE STANDARDS REVISION 16 DATED QUARTER 2, 2019 OR CURRENT EDITION. 7. FINAL QUANTITIES SHALL BE COORDINATED AND VERIFIED IN FIELD. 8. ADDITIONAL SIGNAGE NOT SHOWN ON GRAPHICS PLAN (E.G. FIRE LANES) MAY BE REQUIRED PER LOCAL CODE AND/OR AHJ. SUB-CONTRACTOR SHALL COORDINATE WITH LOCAL AHJ AND PROVIDE AS REQUIRED. 9. MOUNT SIGNAGE ACCORDING TO LOCAL CODES. 10. TYPICAL SIGN FONT IS SET IN AERIAL. PAVEMENT GRAPHIC NOTES: 11. TYPICAL SIGN FONT IS SET IN AERIAL. 12. TYPICAL SIGN FONT IS SET IN AERIAL. 13. TYPICAL SIGN FONT IS SET IN AERIAL. 14. TYPICAL SIGN FONT IS SET IN AERIAL. 15. TYPICAL SIGN FONT IS SET IN AERIAL. 16. TYPICAL SIGN FONT IS SET IN AERIAL. 17. TWO COAT APPLICATION REQUIRED FOR ALL PAVEMENT GRAPHICS. 2. REFER TO CIVIL FOR PAINTED GRAPHIC ARROWS AND ADDITIONAL PAVEMENT GRAPHIC CRITERIA. THERMAL APPLIED GRAPHICS / PAVEMENT PAINT	See See Succession See Succession Sect
INFORMATION. SEE PAVEMENT GRAPHIC DETAIL PG-14	TA1 / PP1WHITETA2 / PP2RED (PANTONE 485C) (RAL 3020)TA3 / PP3BLUE (PANTONE 294) (RAL5005)TA4 / PP4GREEN (PANTONE 342) (RAL 6002)TA5 / PP5YELLOW (PANTONE 116) (RAL 1018)NOTE: TWO COAT APPLICATION REQUIRED FOR ALL PAVEMENT GRAPHICS.	CAD File: DN210069601 Title SITE PAVEMENT GRAPHICS DETAILS Sheet No. DN-1

Architecture Engineering Environmental Land Surveying

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2. THESE DETAILS PROVIDE INTENT ONLY. FINAL POST & CONNECTIONS SHALL BE SIZED MEETING LOCAL DOT

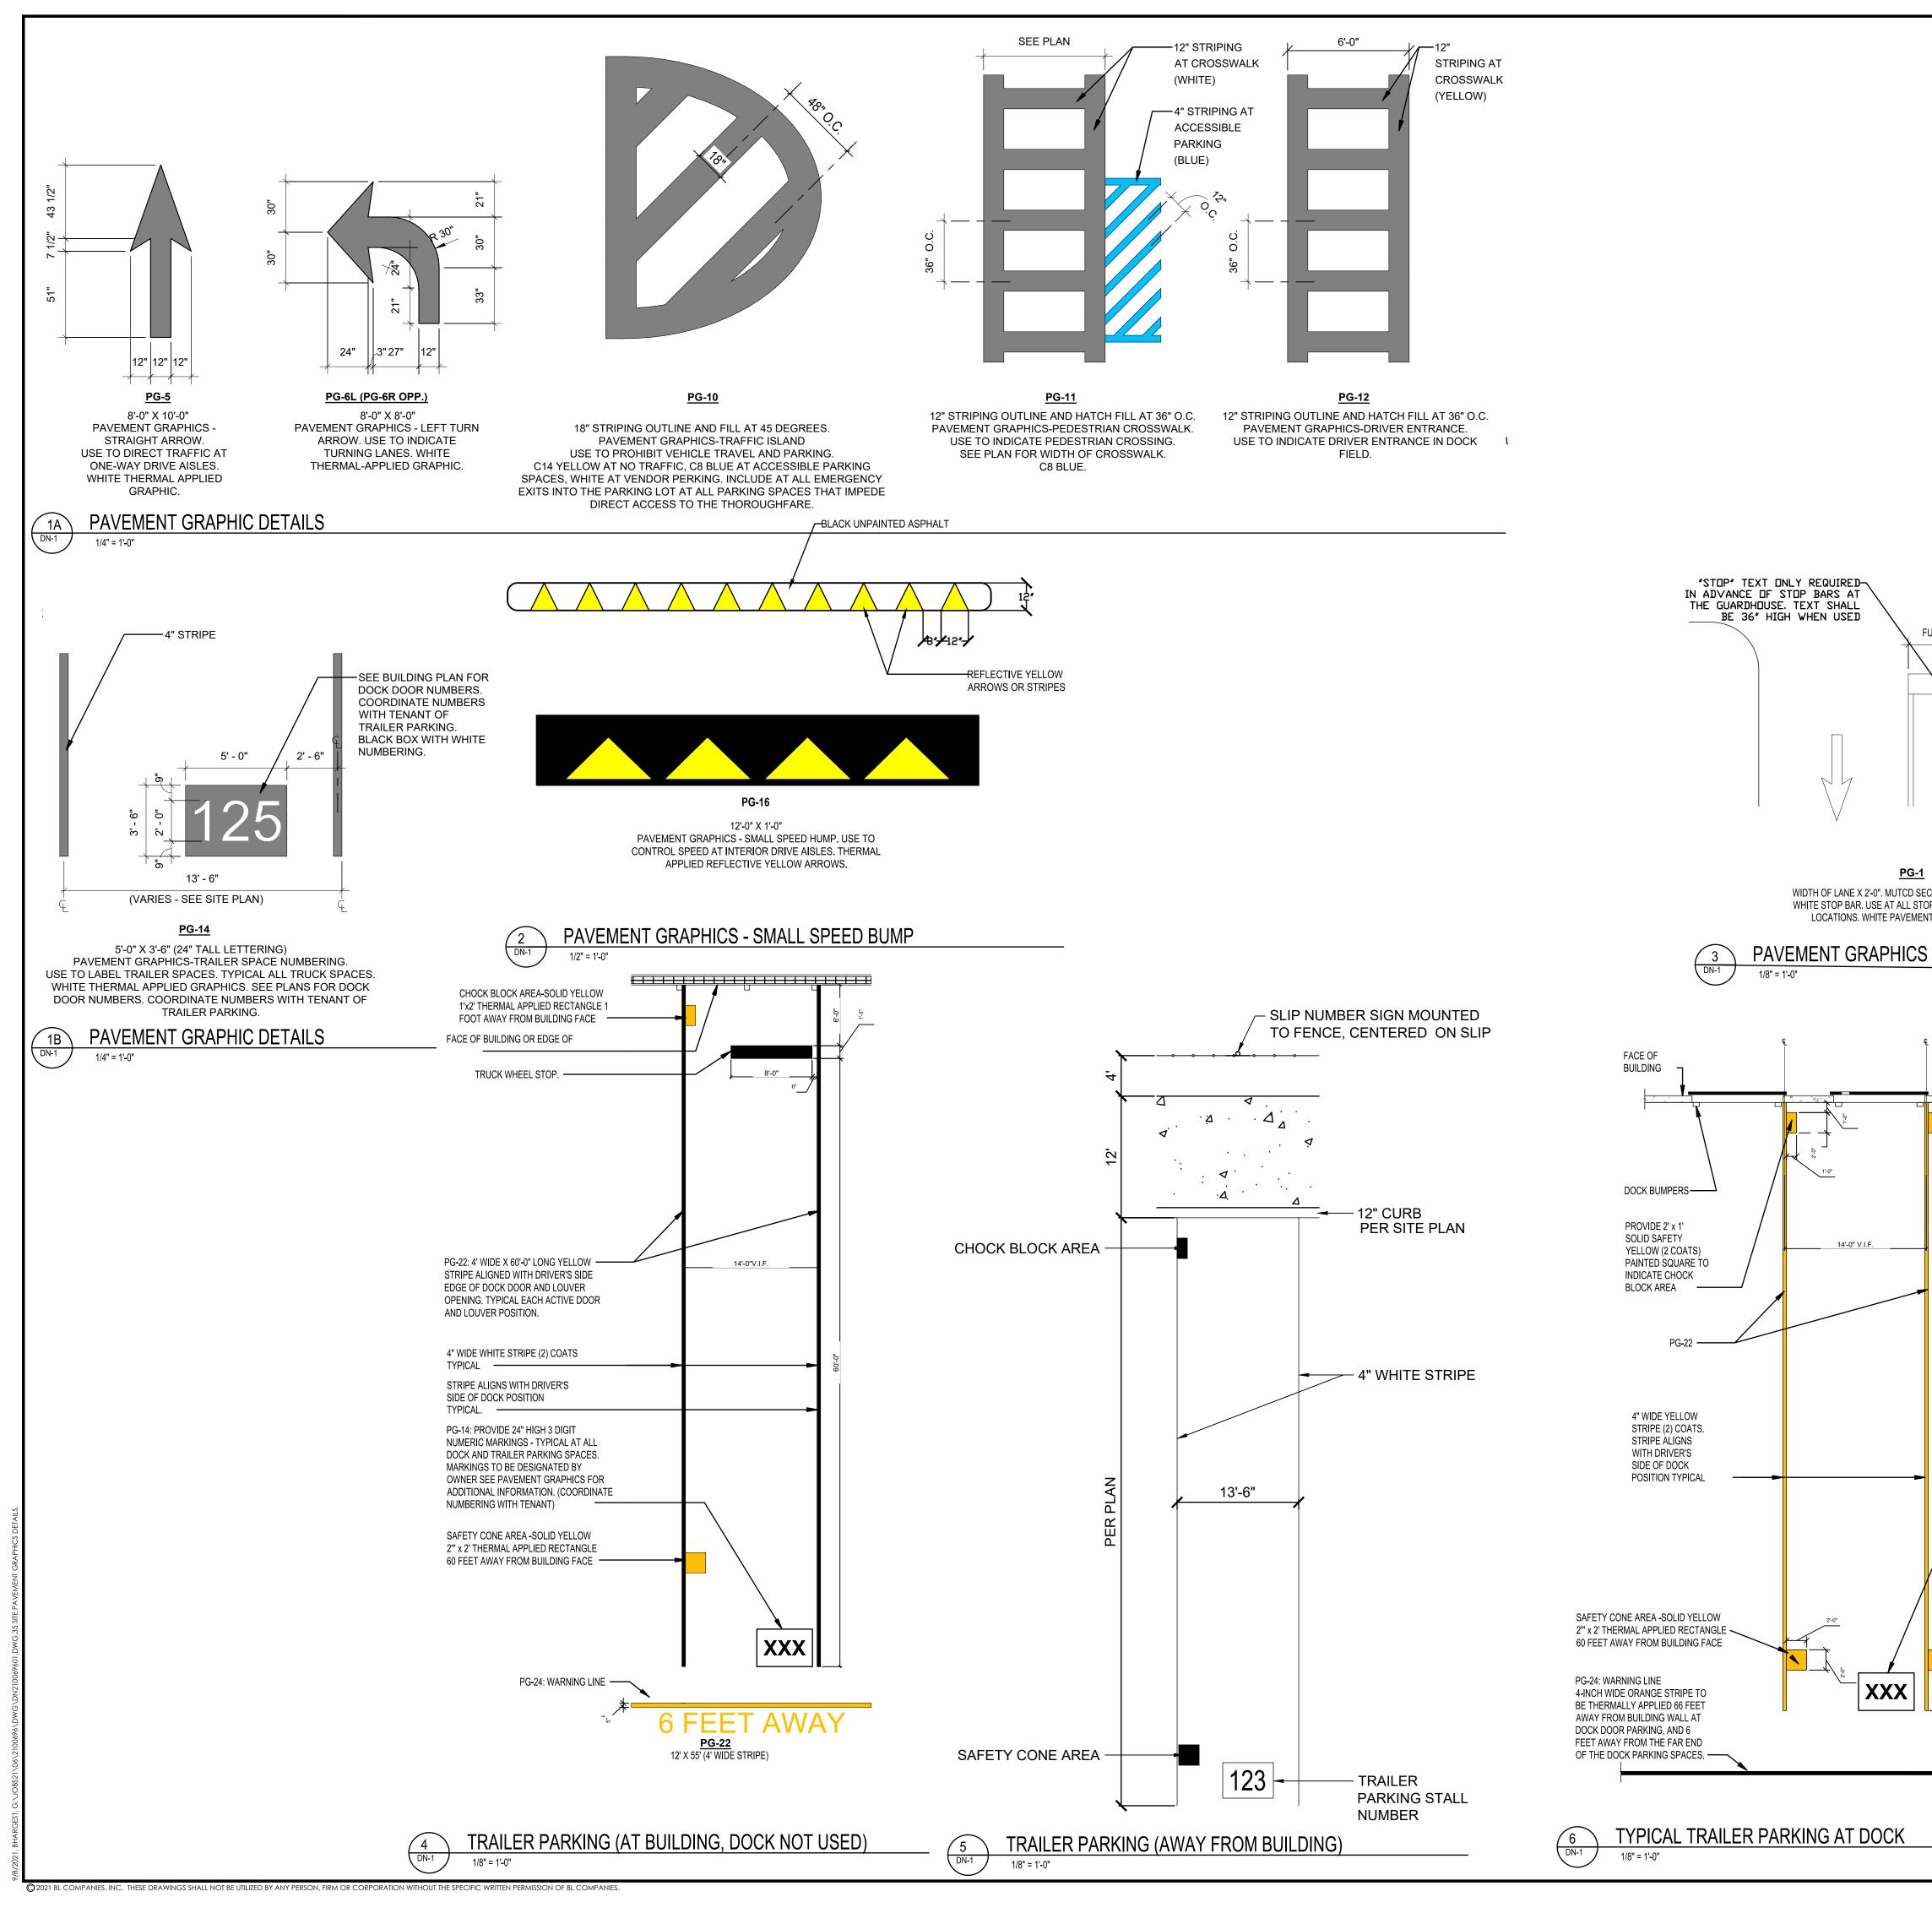SITE SIGNAGE COLOR GENERAL NOTES

ALL SIGNS INDICATED "DOT" SHALL CONFORM TO COLOR AND REFLECTANCE SPECIFICATIONS OF THE MUTCD

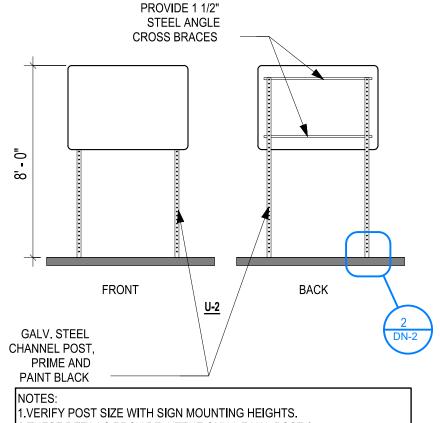MUTCD (MANUAL ON UNIFORM TRAFFIC CONTROL DEVICES) HTTP://MUTCD.FHWA.DOT.GOV/KNO-COLORSPEC.HTM

MUTCD COLOR SPECIFICATIONS

COLOR SPECIFICATIONS (23 CFR 655) THE COLOR SPECIFICATIONS ARE USED TO DETERMINE THE COLOR OF SIGN SHEETING AND PAVEMENT MARKING MATERIALS FOR DESIGN PURPOSES. MOST OF THE COLOR SPECIFICATIONS WERE LAST REVISED BY THE FINAL RULE; AMENDMENT DATED NOVEMBER 21, 2002. HOWEVER, SOME COLOR SPECIFICATIONS WERE REVISED AND SPECIFICATIONS FOR SOME NEW COLORS WERE ADDED BY THE FINAL RULE DATED DECEMBER 16, 2009. VISIT THE ABOVE LINK FOR MORE INFO.

PANTONE MATCHING COLORS

THE FOLLOWING ARE PANTONE SPECIFICATIONS, FOR PRINTING PURPOSES. THEY PROVIDE A GUIDE FOR SELECTING APPROPRIATE LINK COLORS TO CLOSELY MATCH THE STANDARD COLORS OF TRAFFIC CONTROL SIGNS. NOTE: THERE ARE NO PANTONE AVAILABLE FOR FLUORESCENT COLOR SIGNS.

PANTONE SPECIFICATIONS FOR PRINTING

BROWN - 469, RED - 187, YELLOW - 116, PURPLE - 259, GREEN - 342, BLUE - 294, ORANGE - 152

1. REFER TO SIGNAGE AND STRIPING PLAN FOR LOCATIONS OF SIGNS AND PAVEMENT MARKINGS.

2. ALL SIGNAGE, STRIPING, AND OTHER TRAFFIC CONTROL DEVICES SHALL BE INSTALLED IN CONFORMANCE WITH THE LATEST EDITION OF THE MANUAL ON UNIFORM TRAFFIC CONTROL DEVICES (MUTCD).

3. ALL STRIPING SHALL BE LONG LIFE EPOXY RESIN AND 4" WIDE UNLESS OTHERWISE NOTED. ALL PAVEMENT GRAPHICS SHALL BE HOT-APPLIED THERMOPLASTIC (REFLECTIVE).

4. COLOR SHALL BE WHITE ON ASPHALT AND YELLOW ON CONCRETE, UNLESS OTHERWISE NOTED.

5. ASPHALT SPEED HUMPS AND SPEED BUMPS SHALL BE USED IN COLDER CLIMATES WHERE SNOW REMOVAL EQUIPMENT IS INTENDED TO BE USED. RUBBER SPEED HUMPS AND SPEED BUMPS MAY BE USED IN WARMER CLIMATES OR REGIONS WHERE CONCRETE PAVEMENT IS PREVALENT.

6. ALL PROPOSED SIGNAGE AND STRIPING SHALL BE INSTALLED IN ACCORDANCE WITH THE TENANT FULFILLMENT WORLDWIDE REAL ESTATE SIGNAGE STANDARDS

REVISION 16 DATED QUARTER 2, 2019 OR CURRENT EDITION. 7. FINAL QUANTITIES SHALL BE COORDINATED AND VERIFIED IN FIELD.

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10. TYPICAL SIGN FONT IS SET IN AERIAL.



<u>AS-22</u> 12" X 18" **TENANT SIGNAGE -**

USE TO IDENTIFY DROP OFF/PICK UP ZONES. POST AND PANEL MOUNT.

NOTE:

- 1. AS-16 LAYOUT SHALL BE SITE SPECIFIC. DETAILS SHOWN ARE FOR
- PROTOTYPE BASED ON SIGN LOCATION SHOWN ON SITE PLANS. ORIENTATION OF ARROWS AND SITE AREAS SHALL BE BASED ON SIGN LOCATION.
- 2. ADDITIONAL TENANT SIGNAGE MAY BE ADDED ON AN INDIVIDUAL SITE BASIS.



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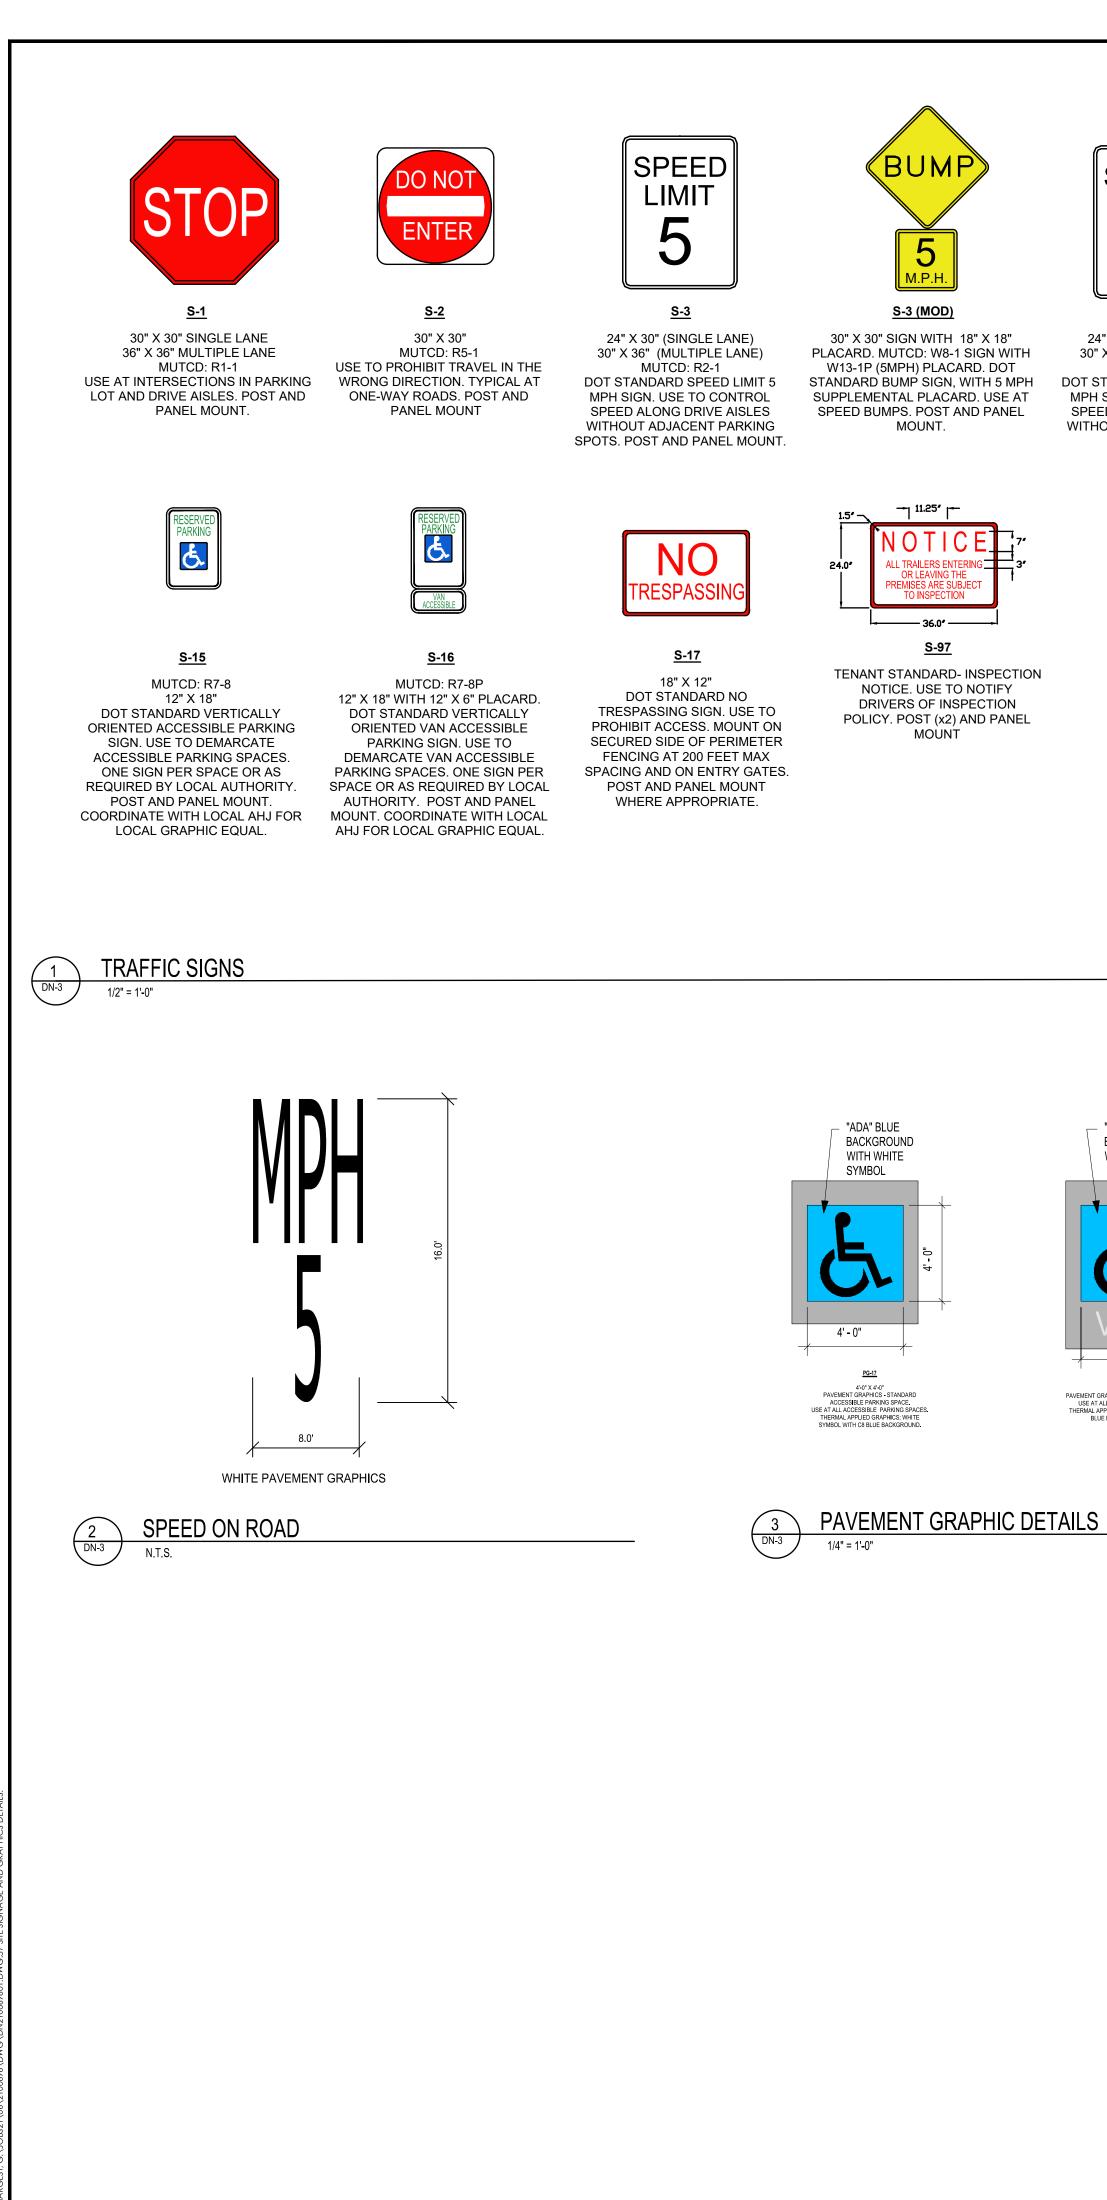
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SITE SIGNAGE AND GRAPHICS DETAILS

DN-2

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Sheet No.






24" X 30" (SINGLE LANE) 30" X 36" (MULTIPLE LANE) MUTCD:R2-1 DOT STANDARD SPEED LIMIT 10 MPH SIGN. USE TO CONTROL SPEED ALONG DRIVE AISLES WITHOUT ADJACENT PARKING SPOTS.



30" X 30" SIGN WITH 18" X 18" PLACARD. MUTCD: W17-1 WITH W13-1P (10MPH) PLACARD. DOT STANDARD SPEED HUMP SIGN, WITH 10 MPH SIGN SUPPLEMENTAL PLACARD. USE AT SPEED HUMPS. POST AND PANEL MOUNT.



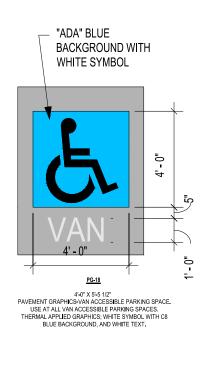

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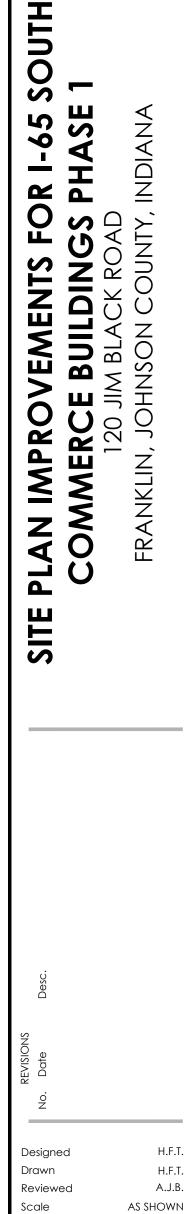
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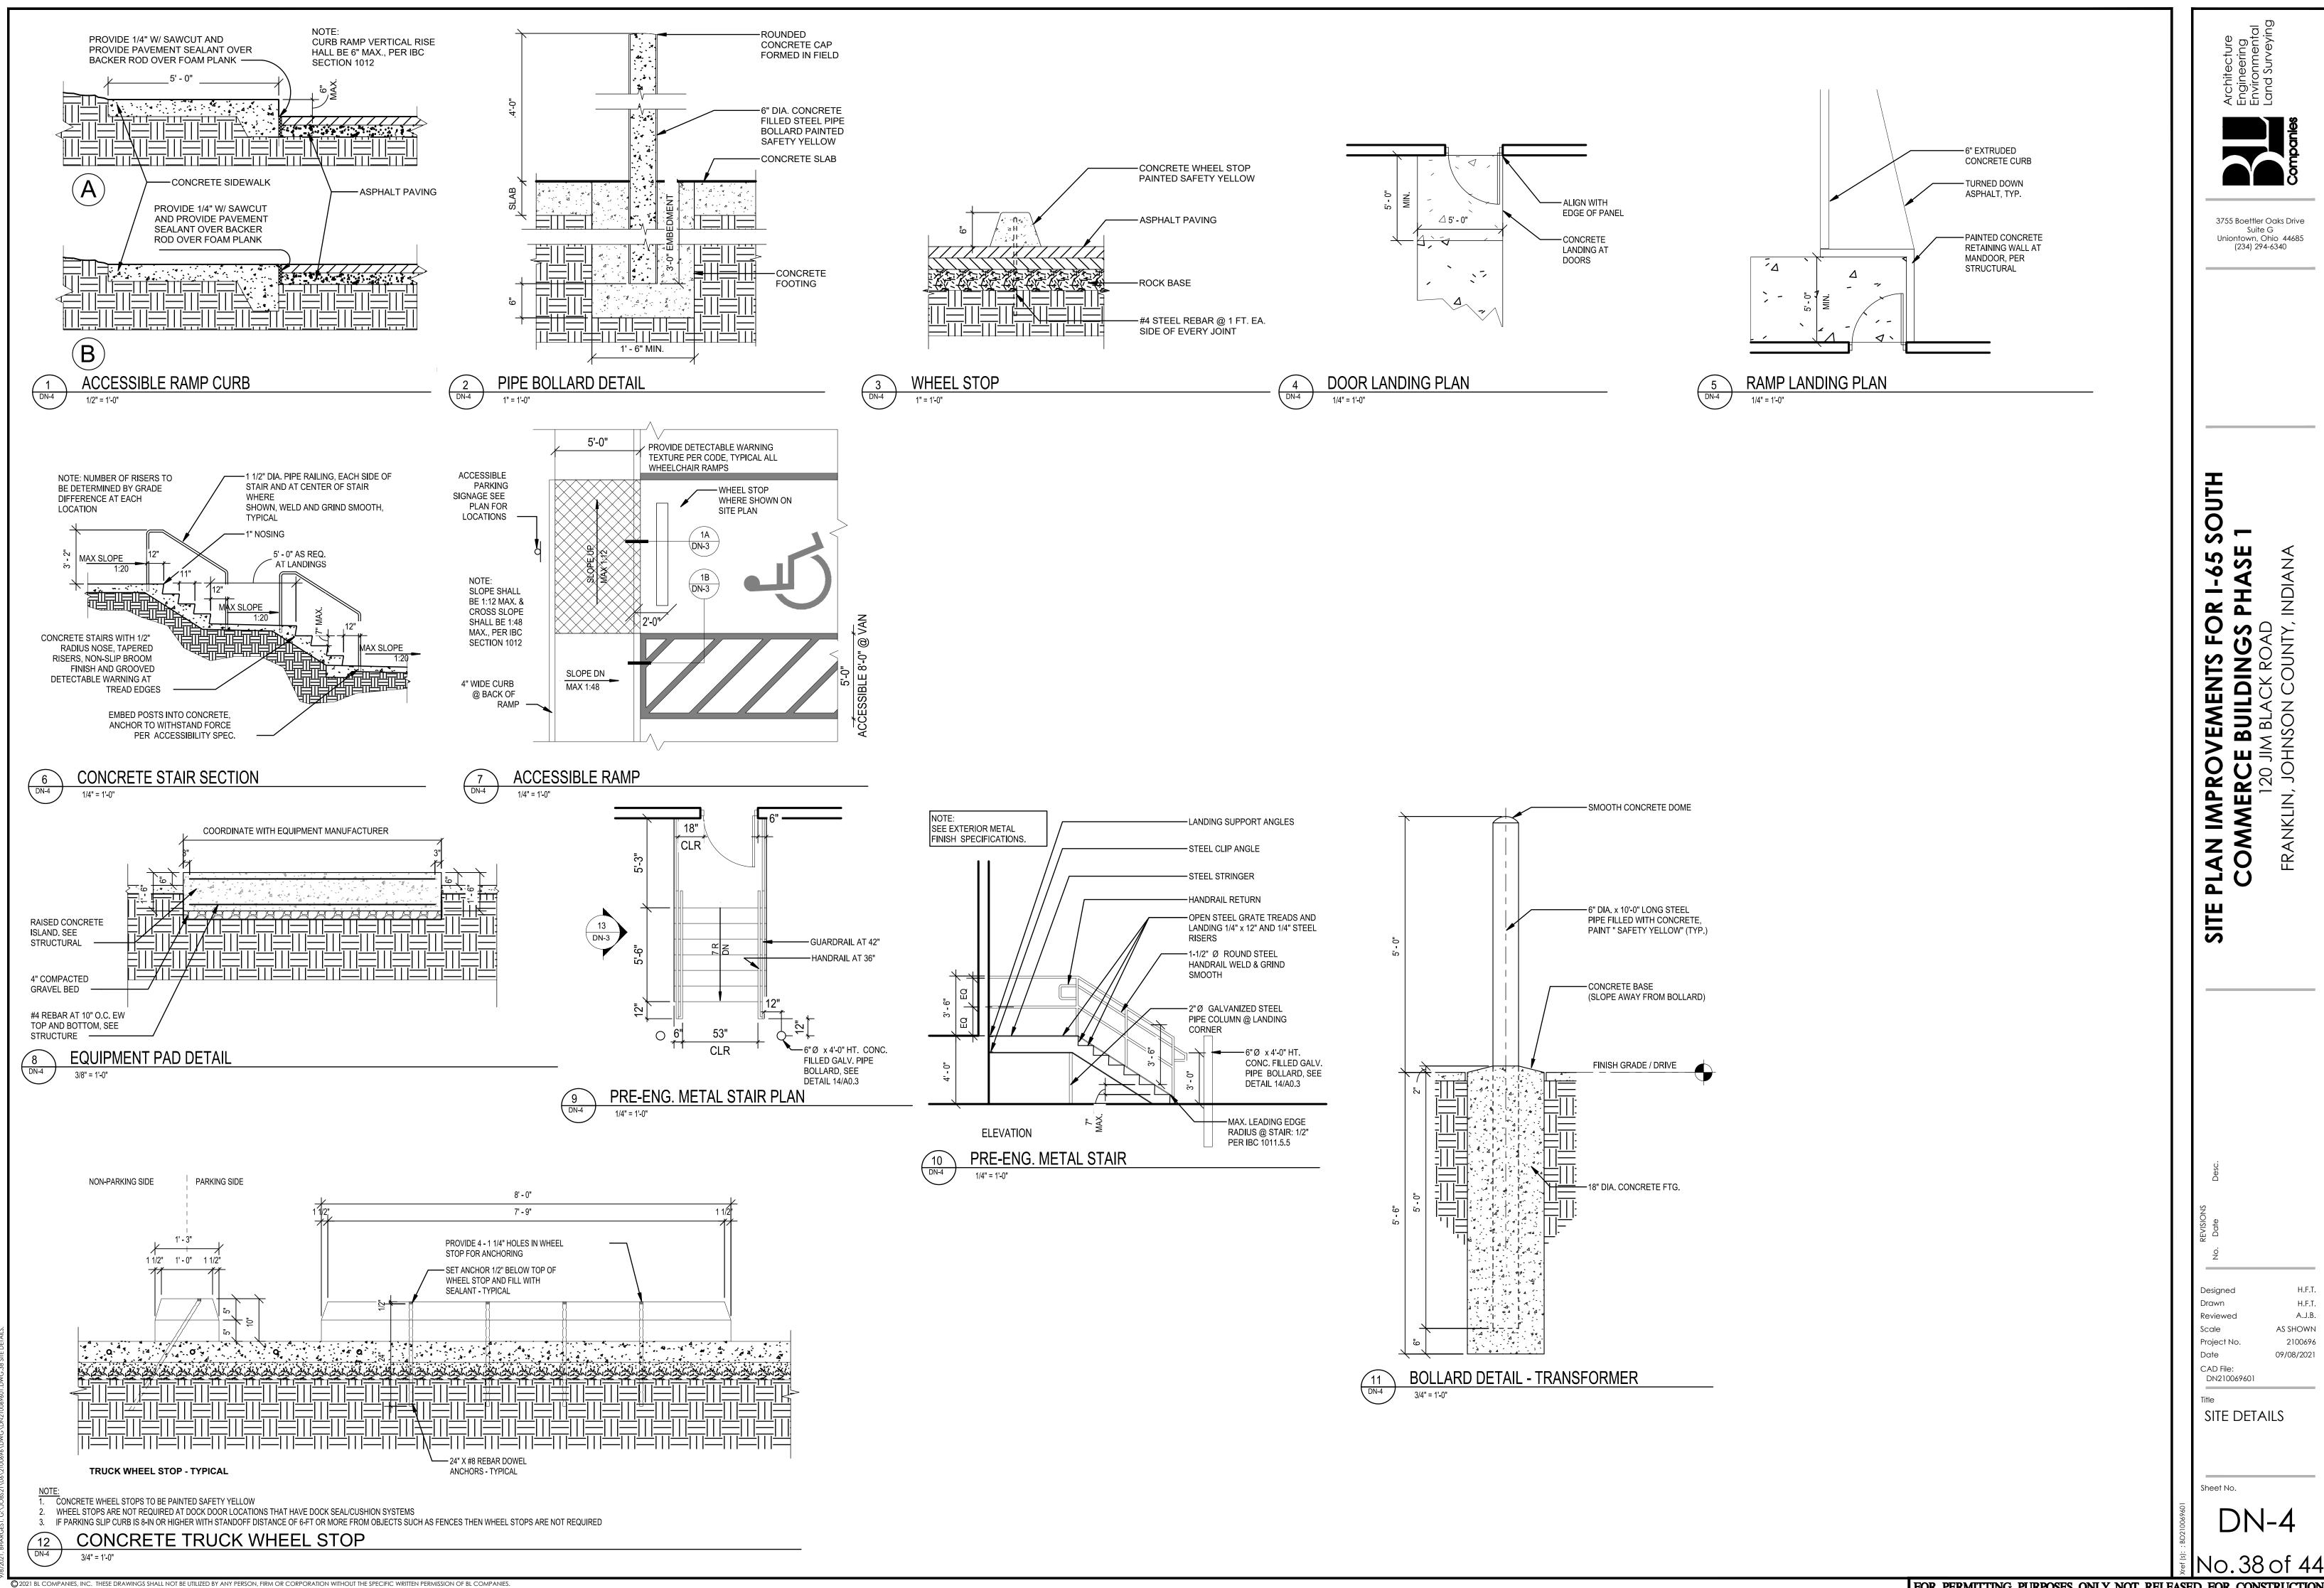
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SITE SIGNAGE AND GRAPHICS Details


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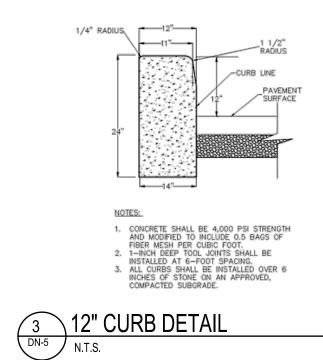
No.37 of 44

Sheet No.





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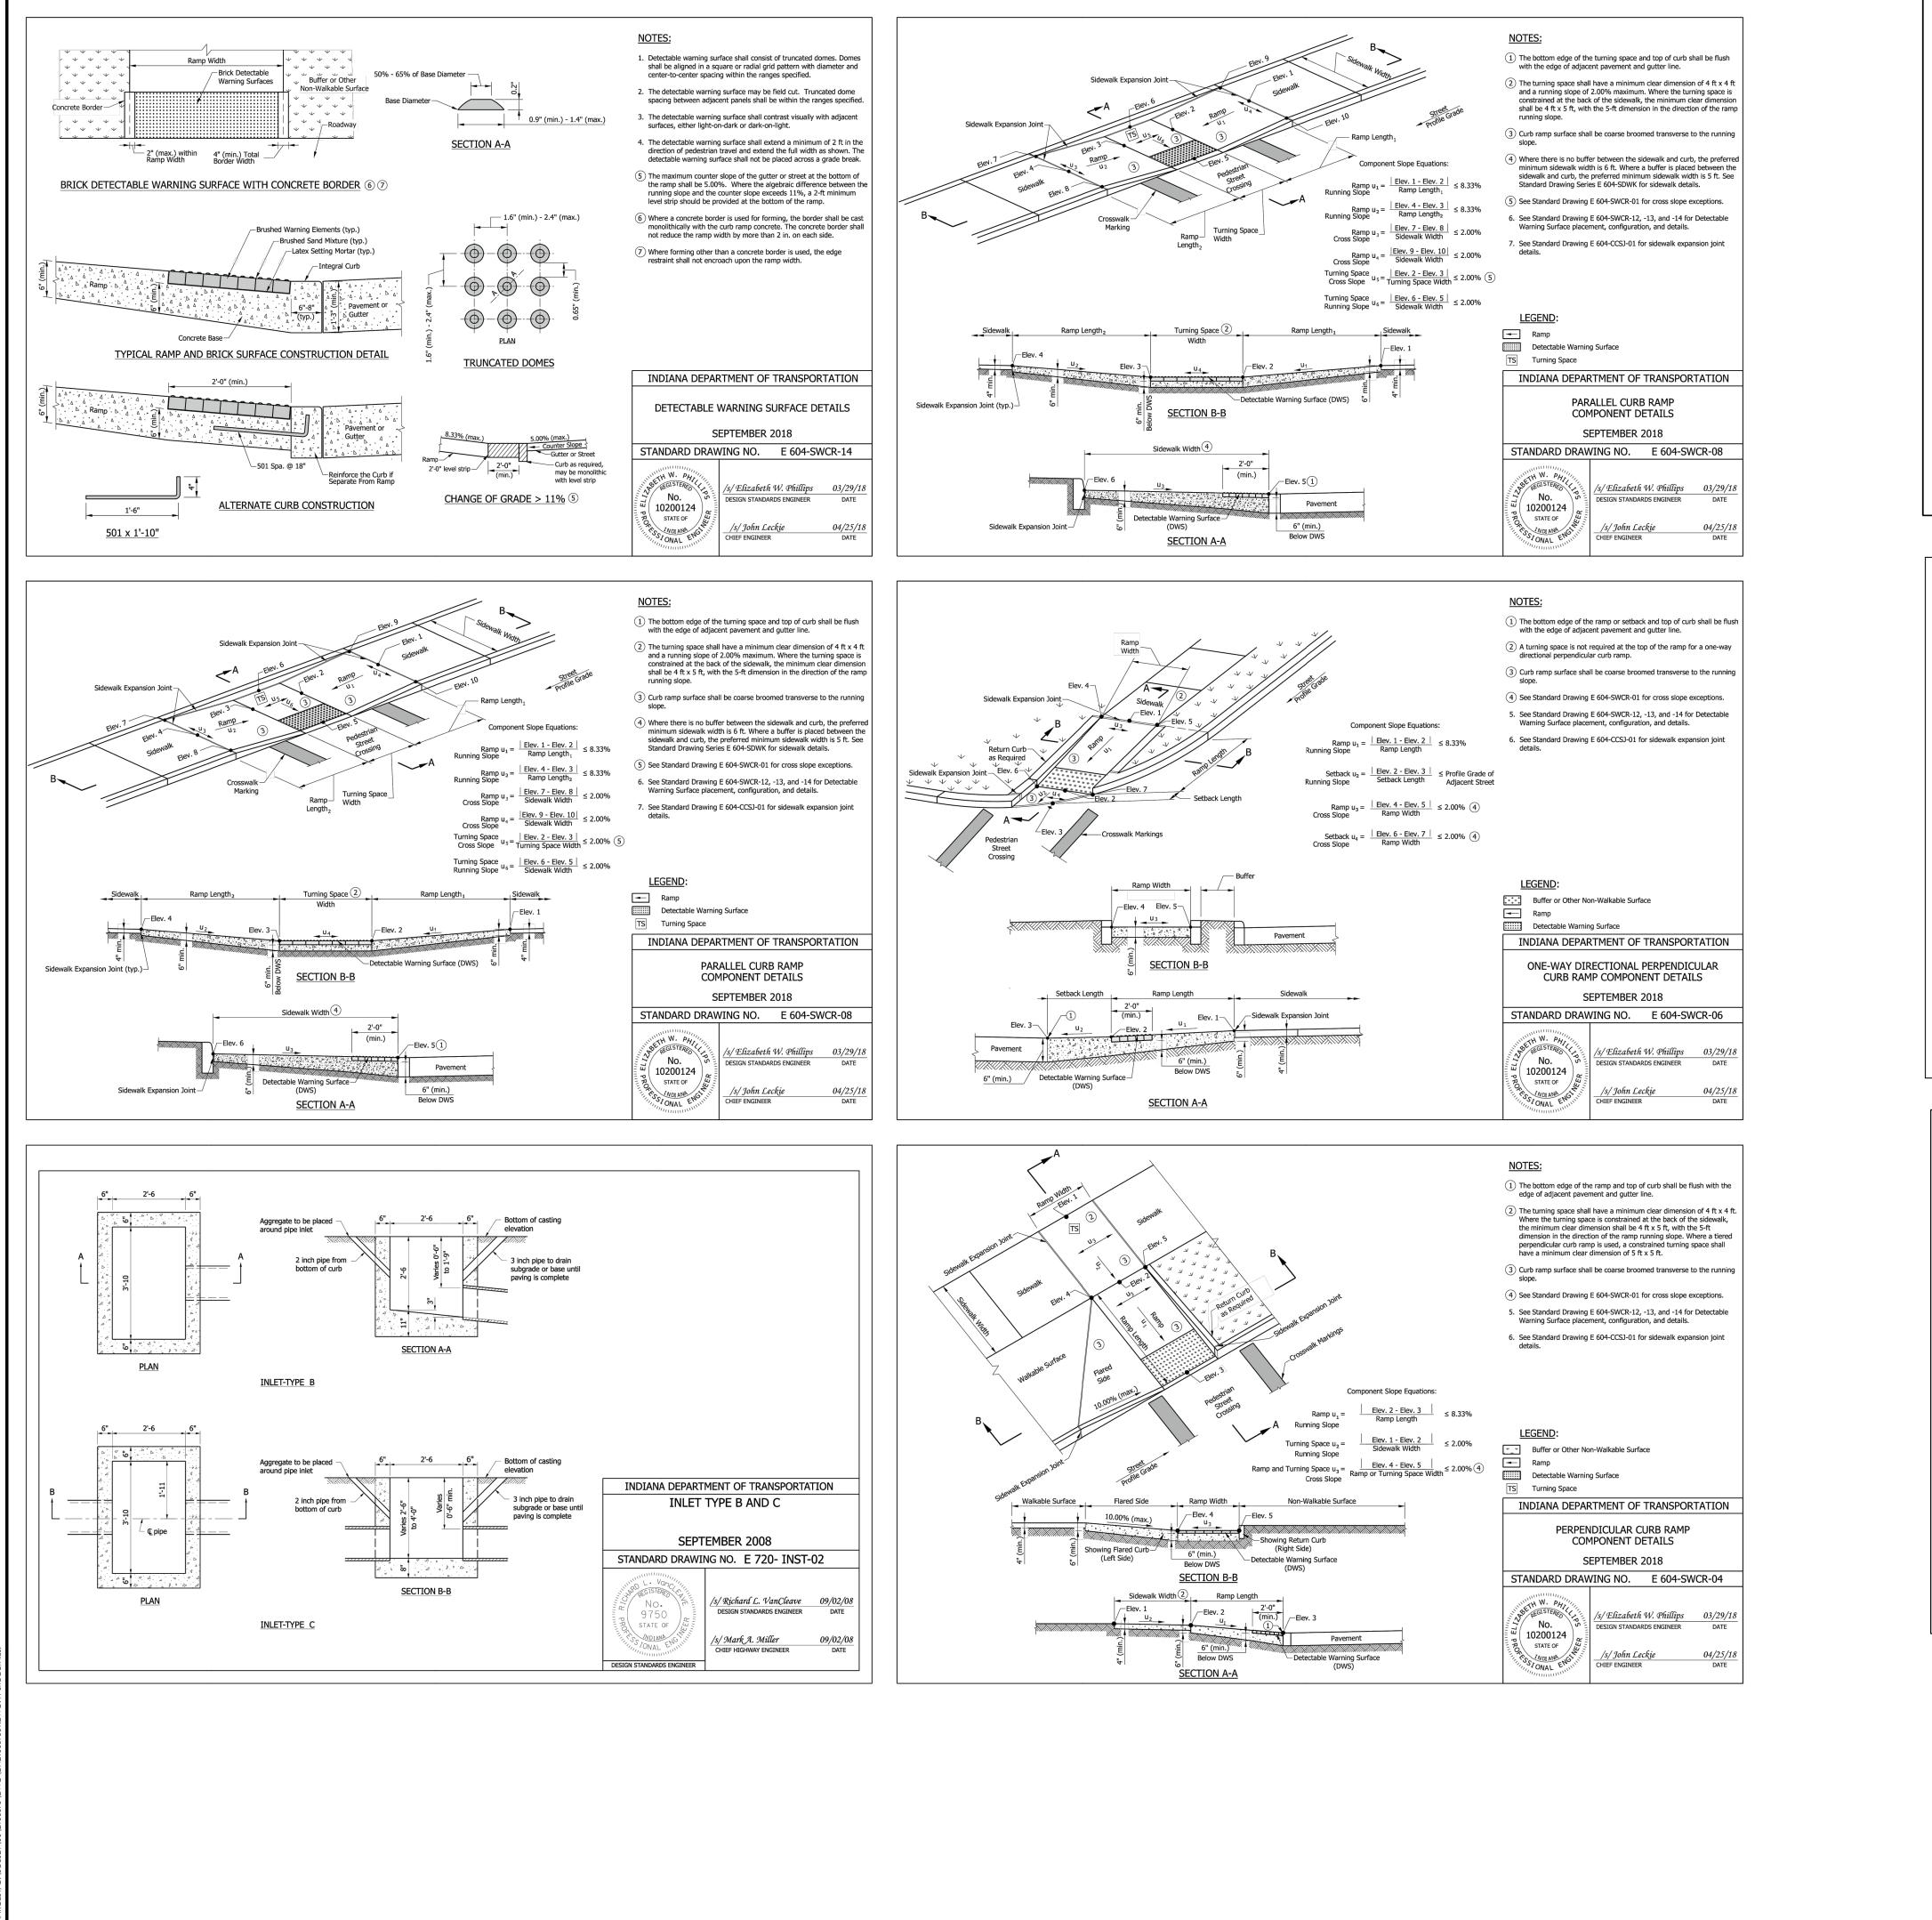





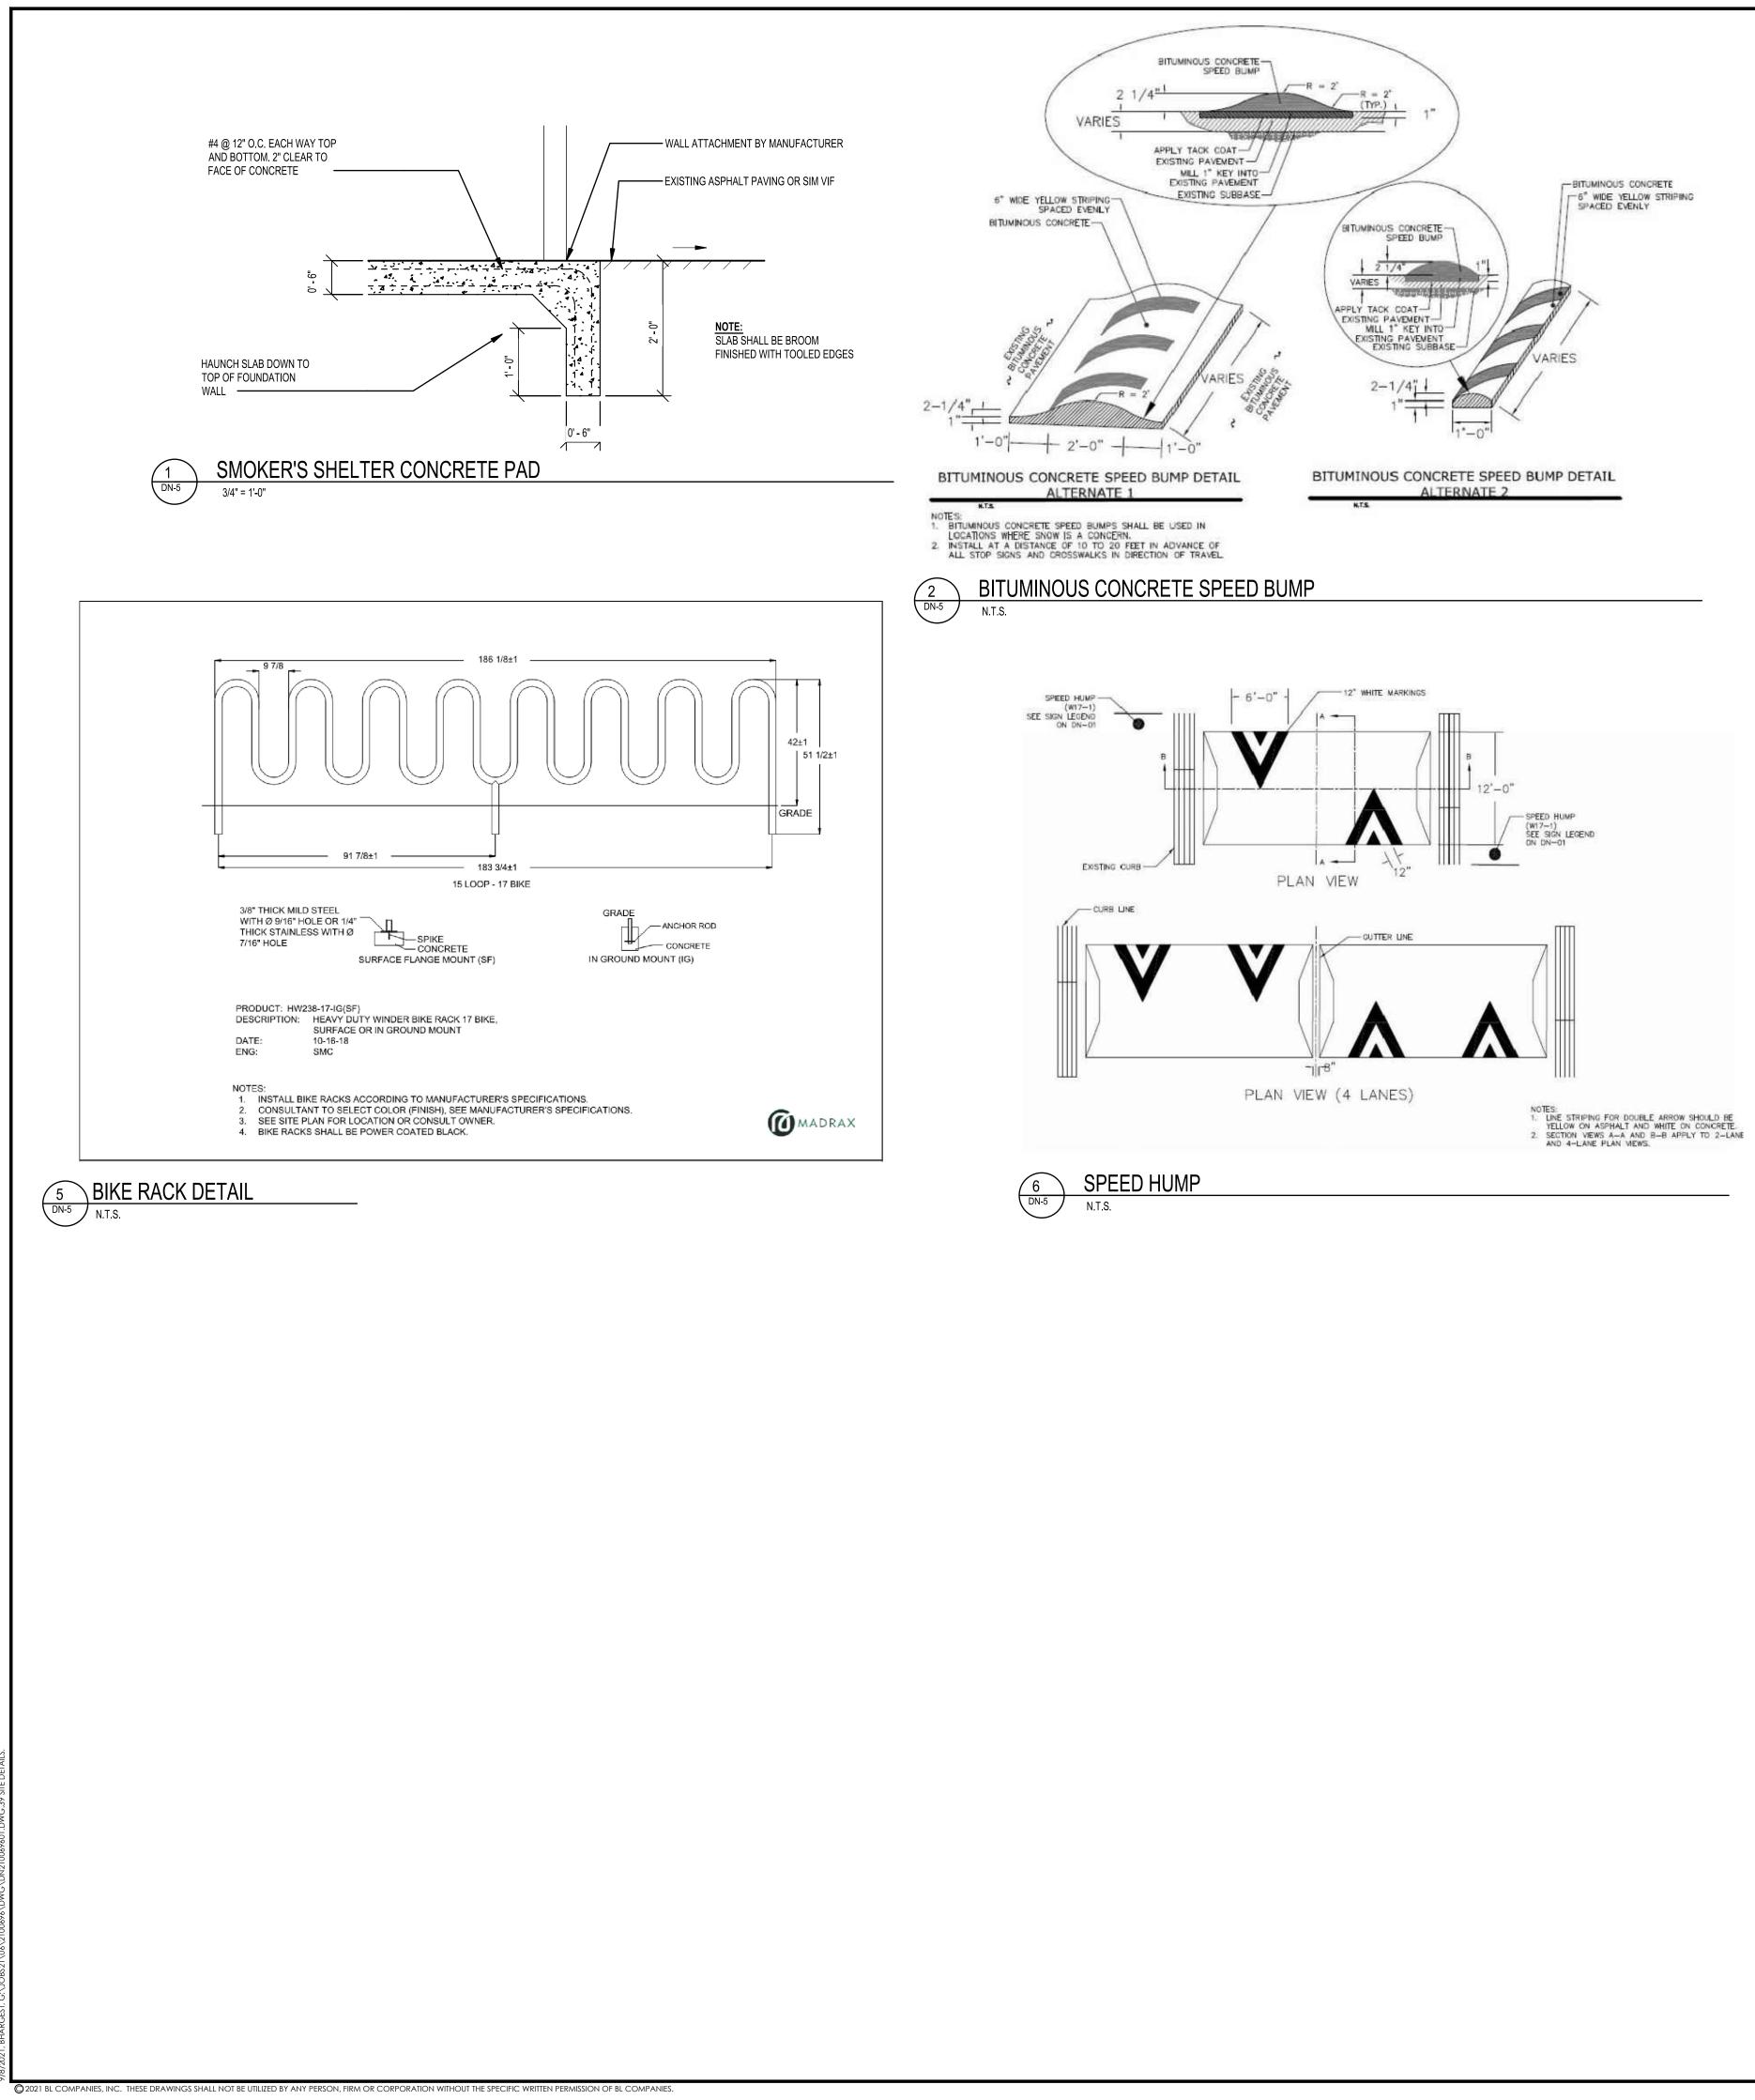



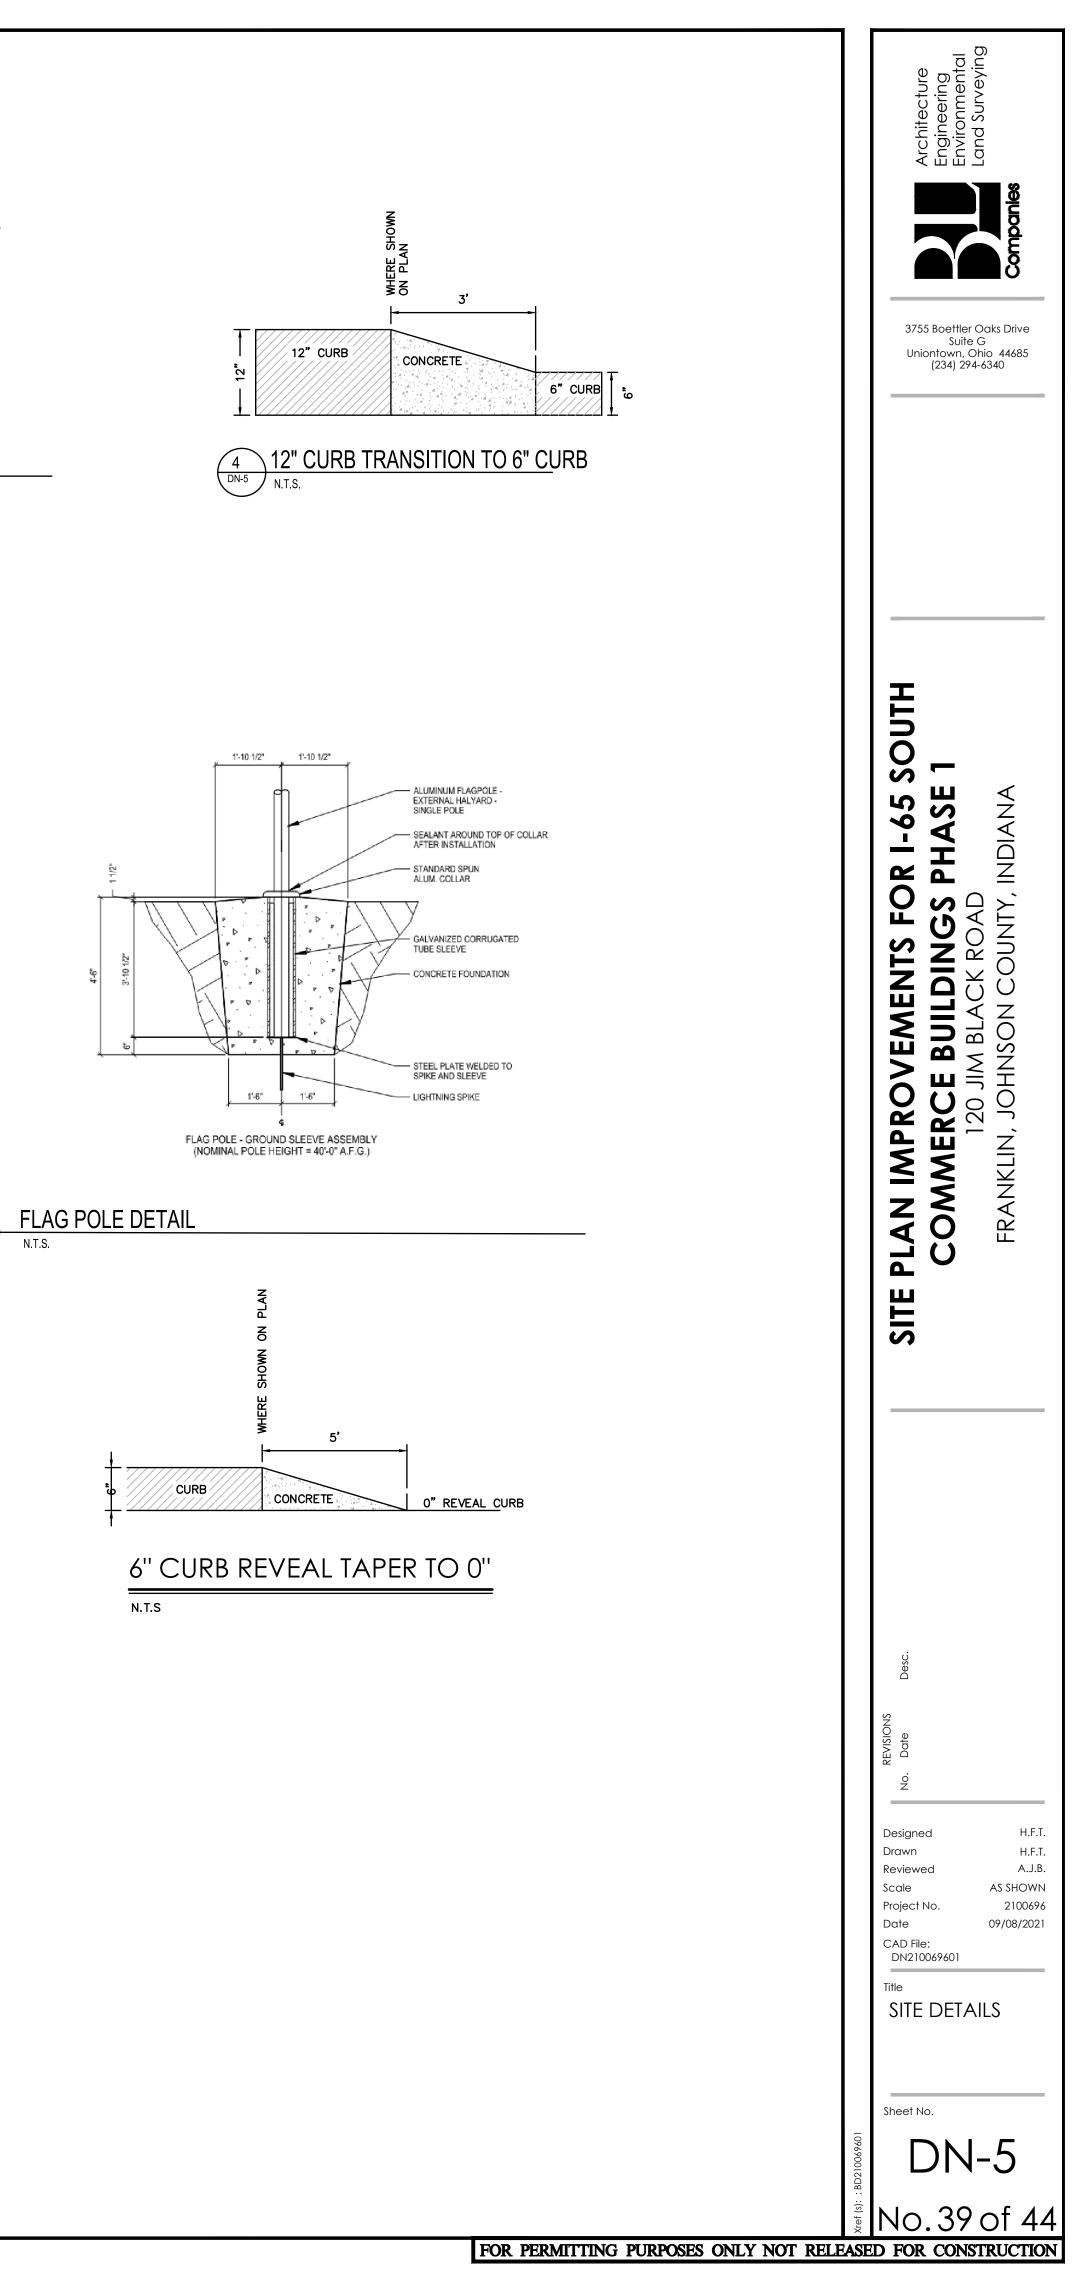


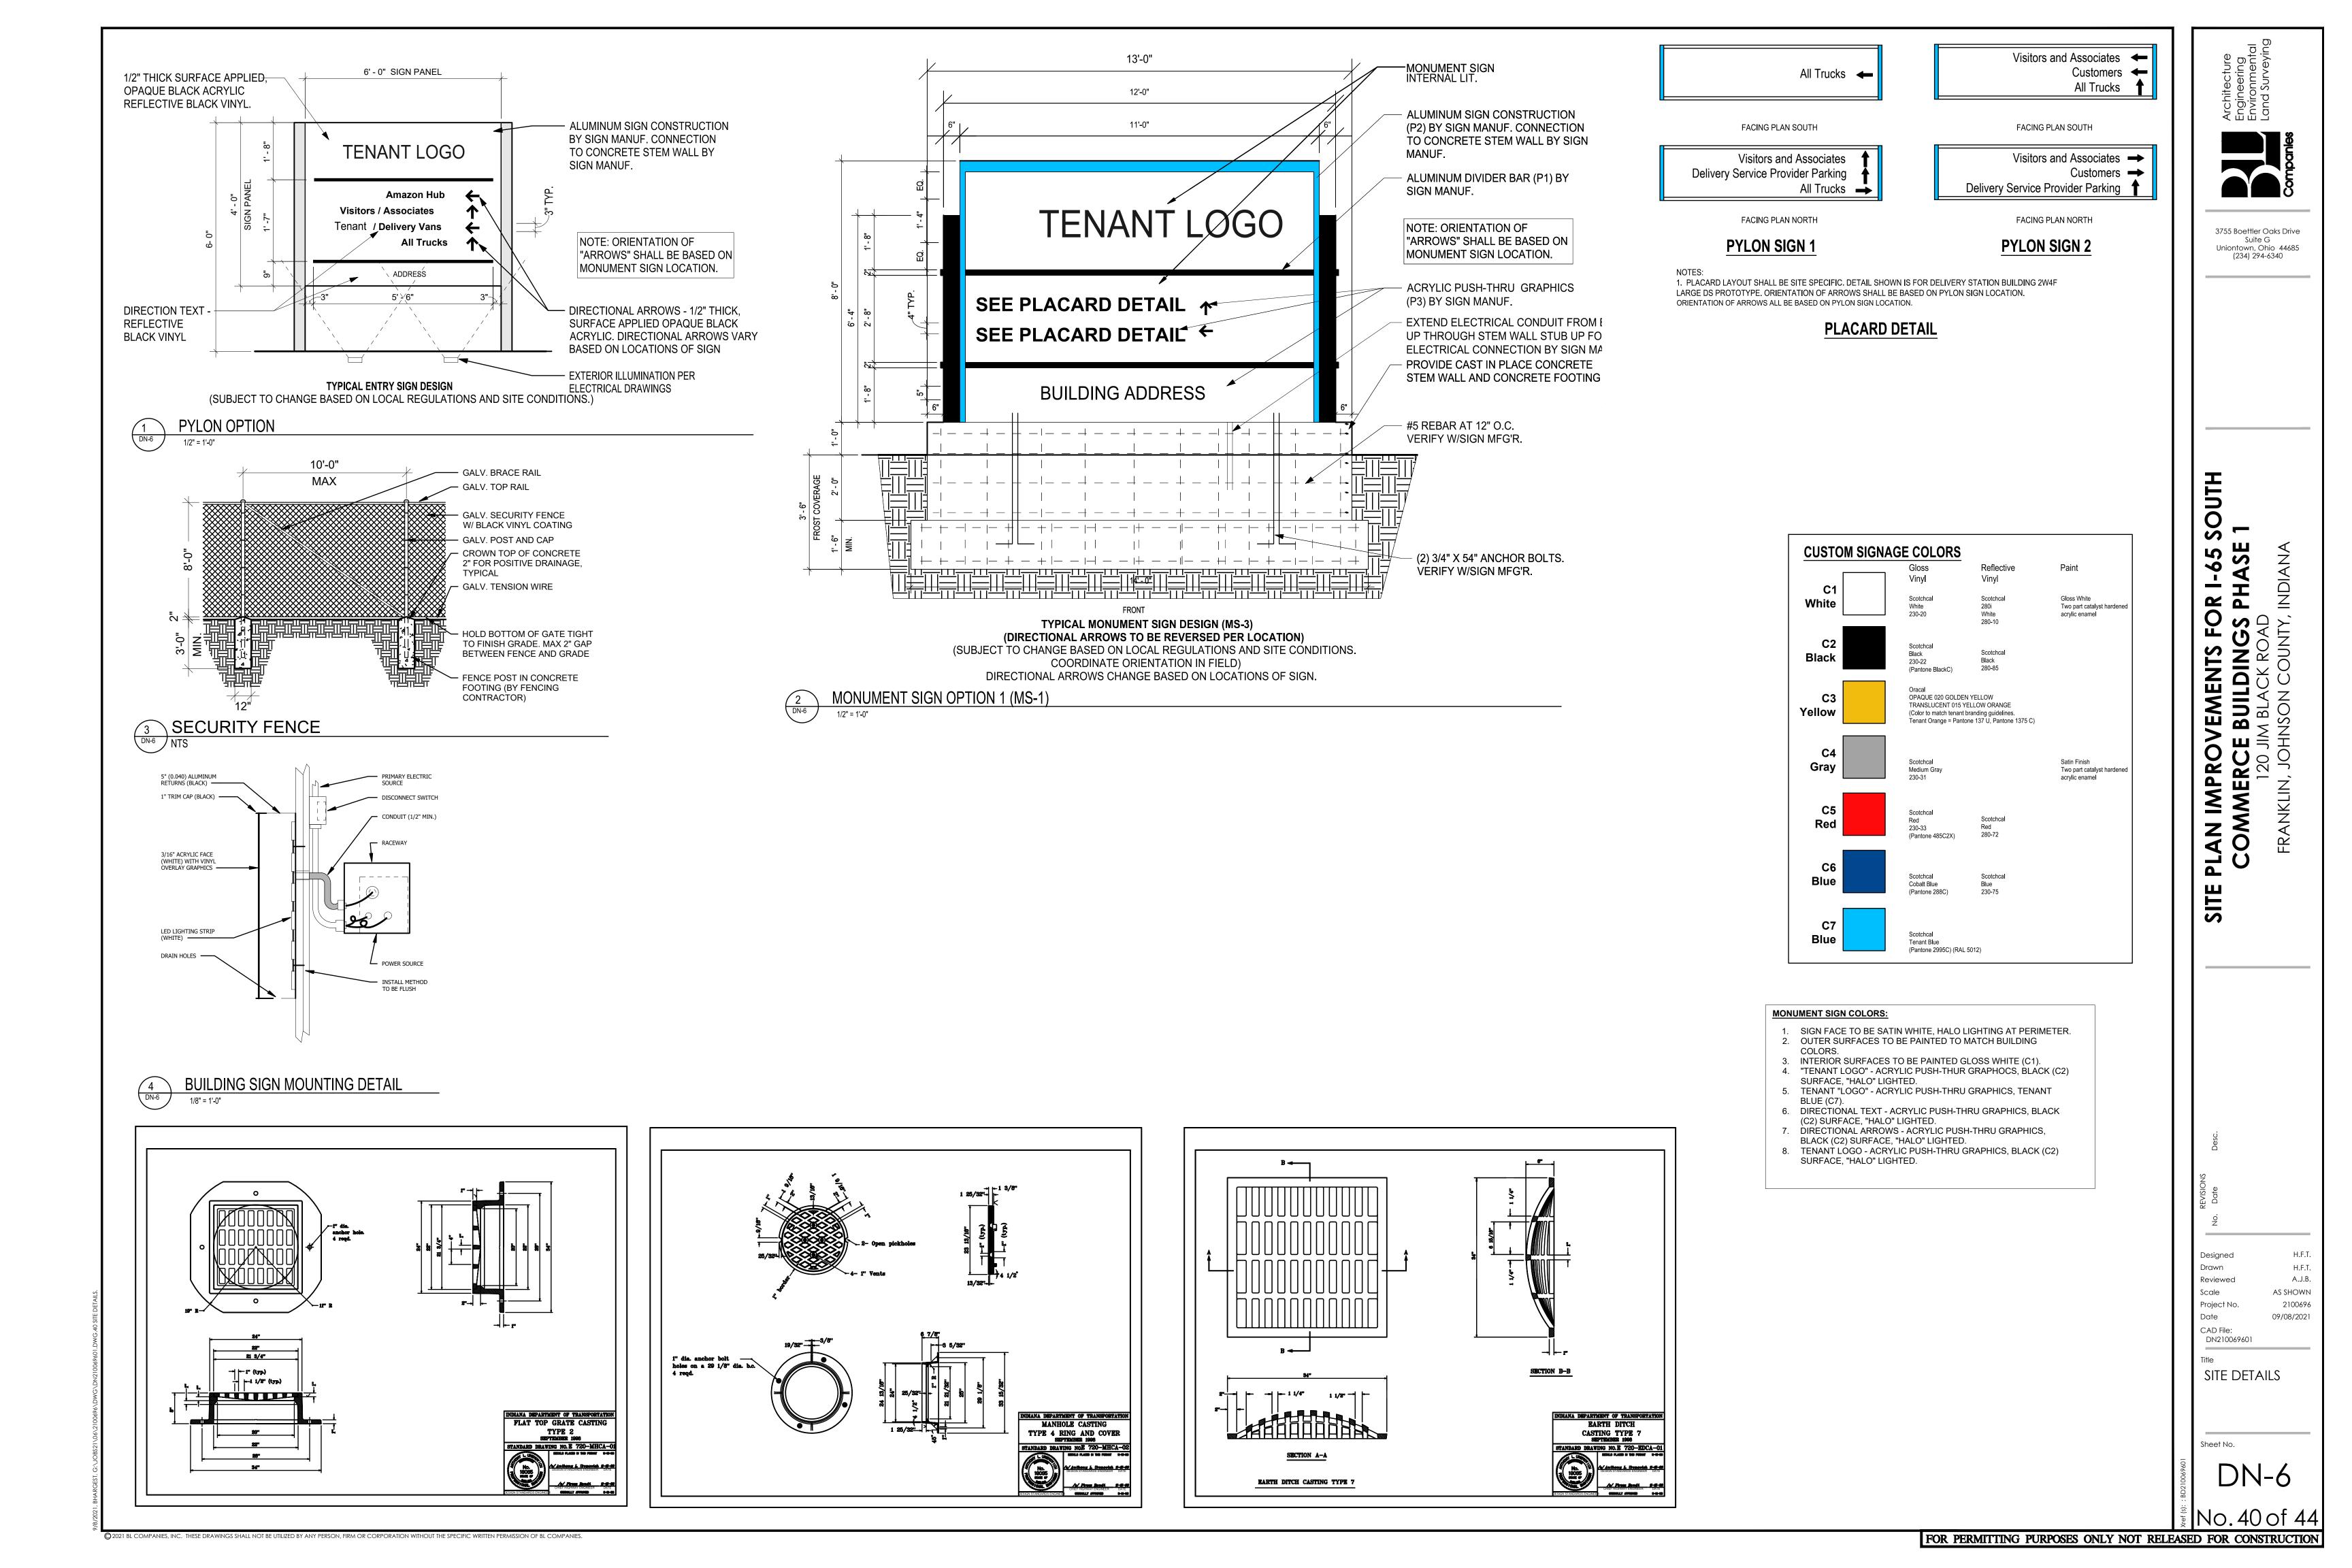


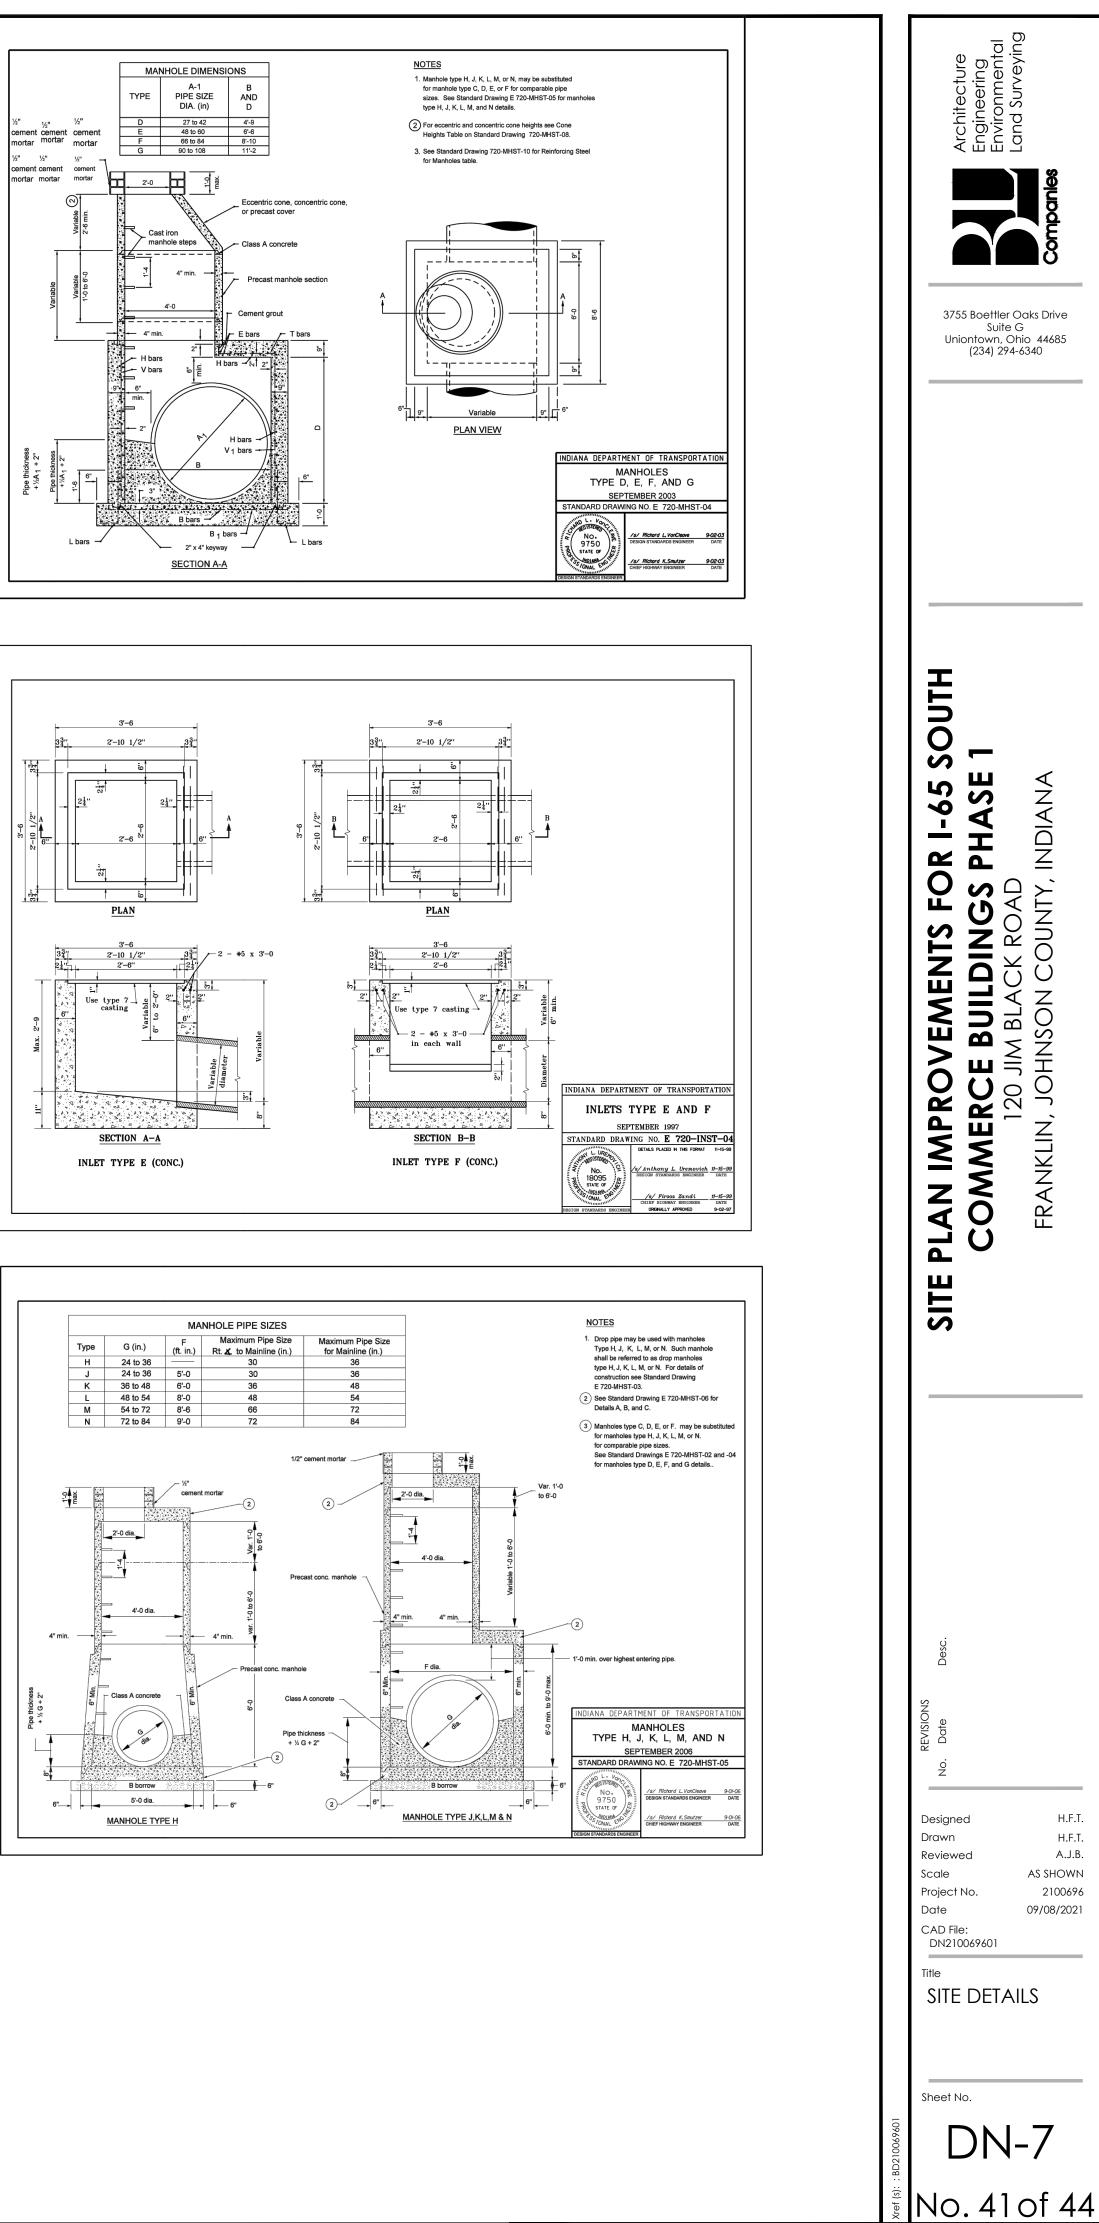



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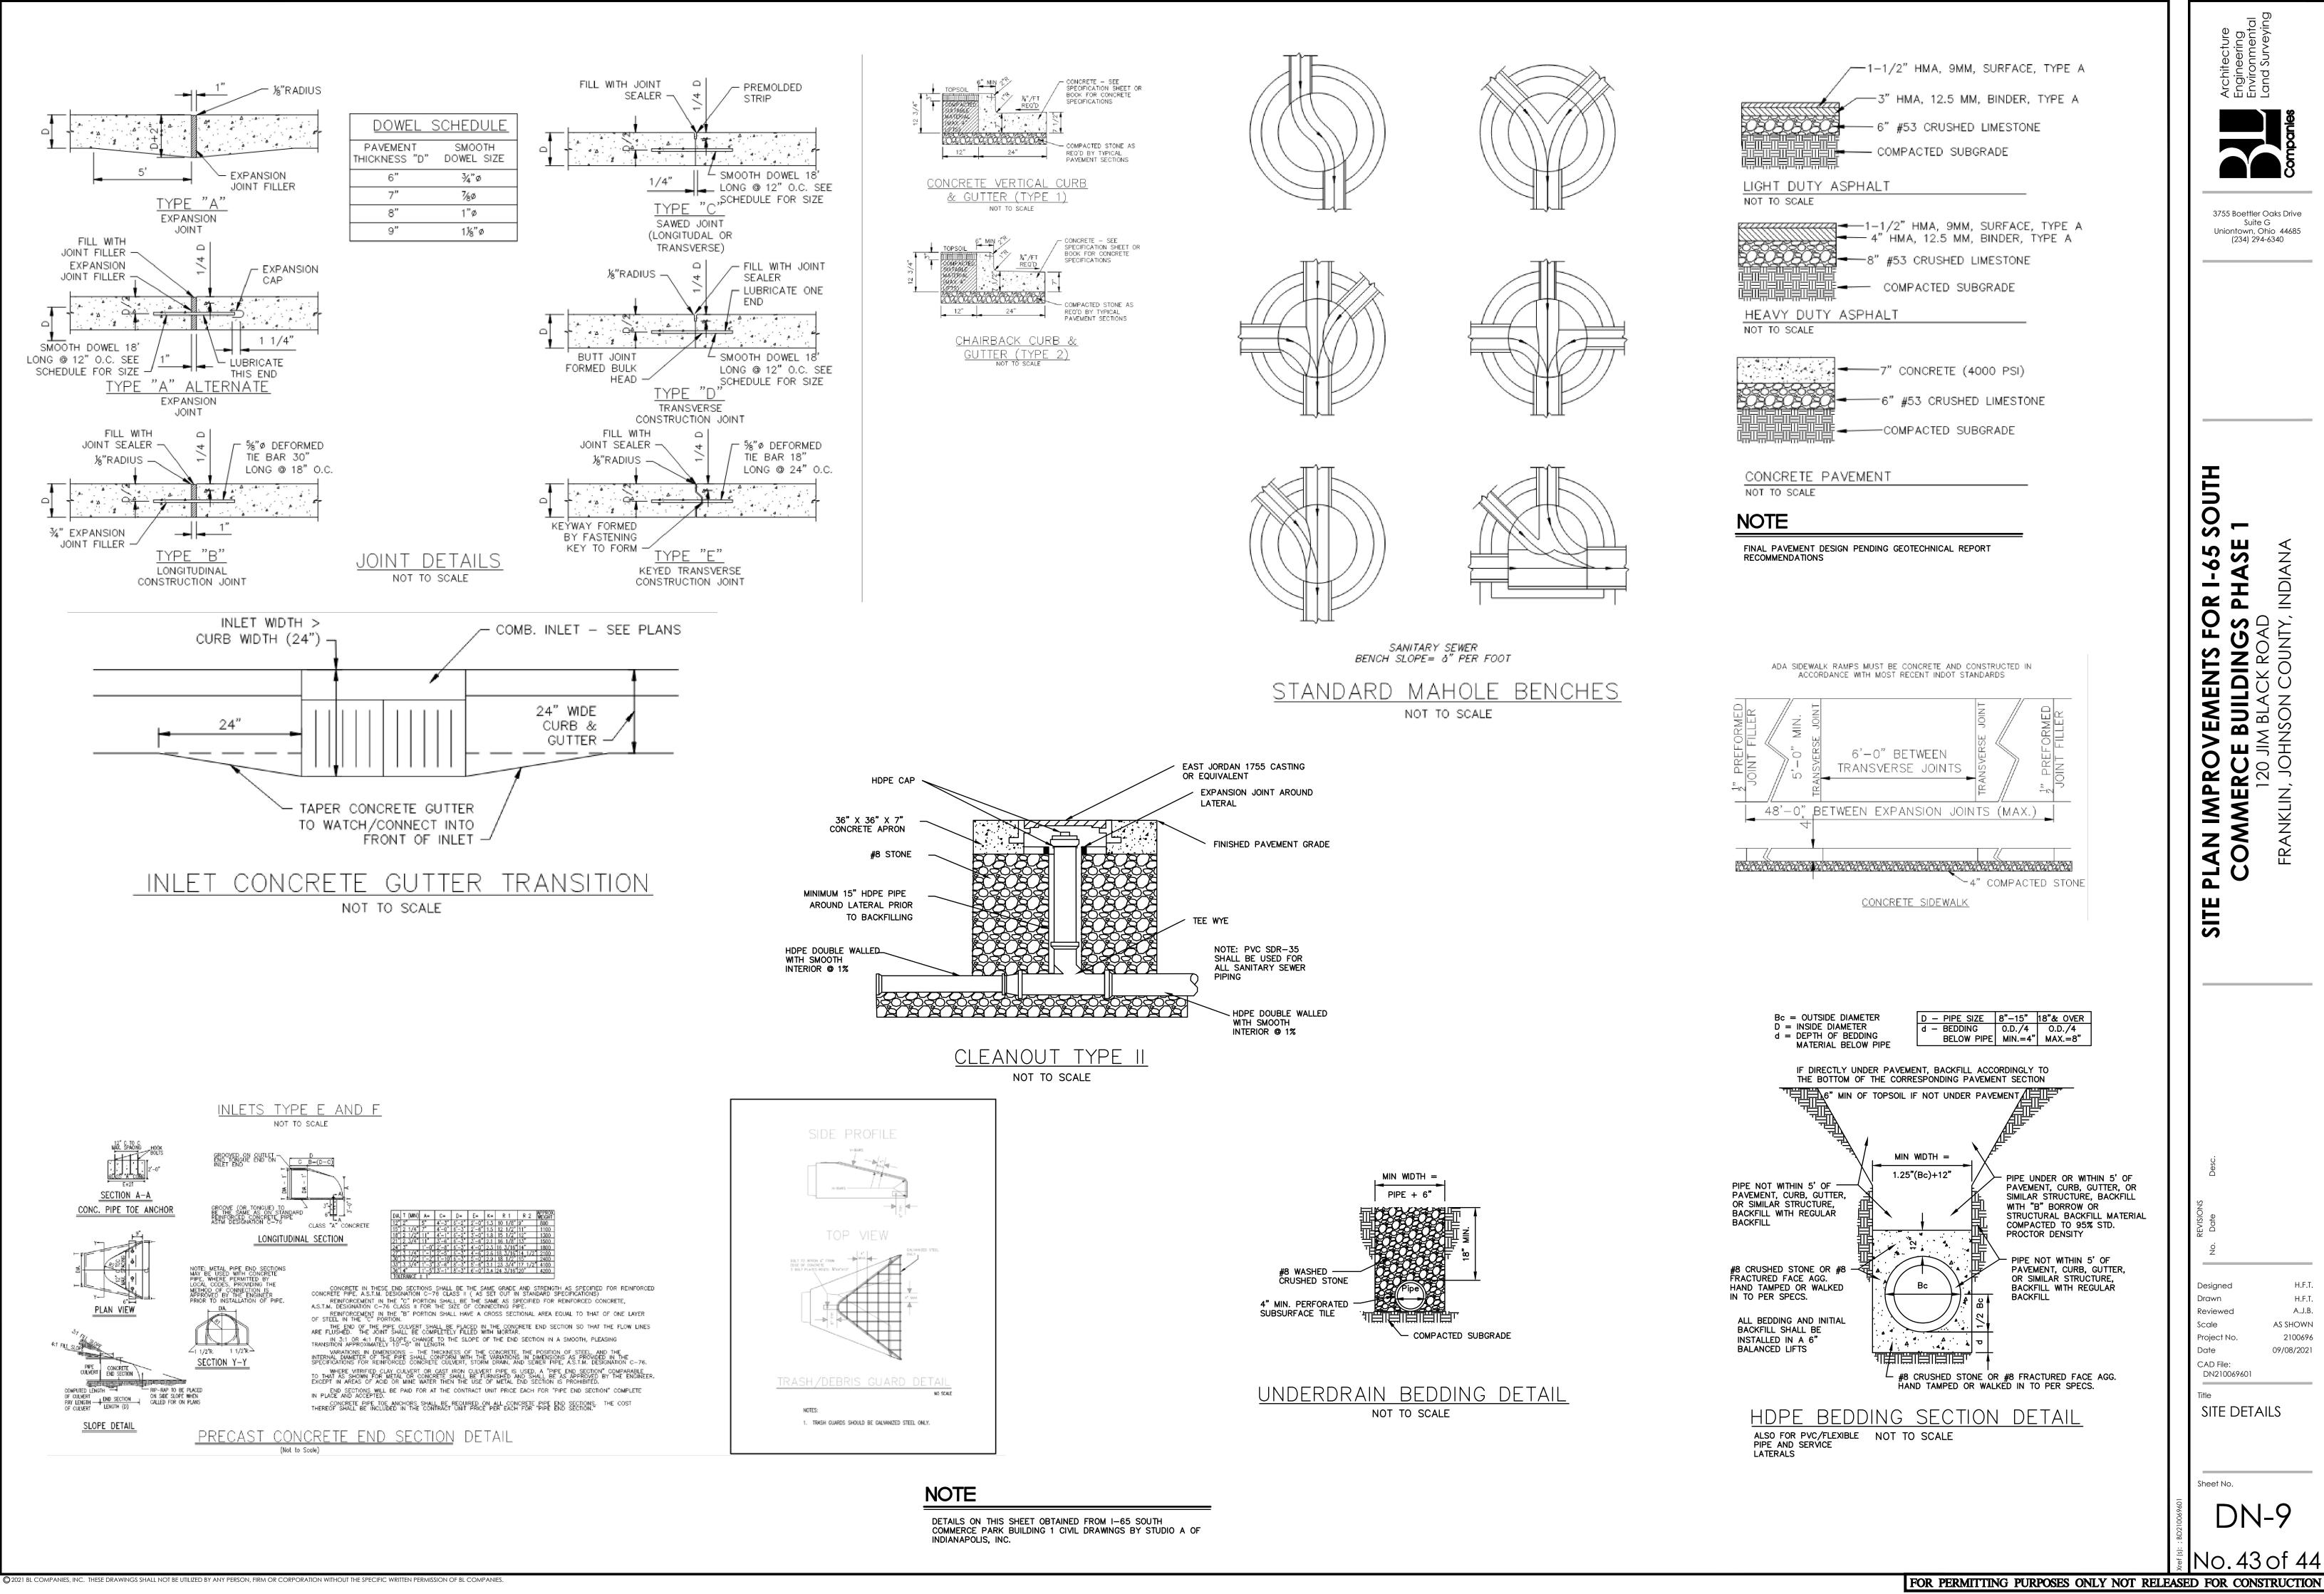


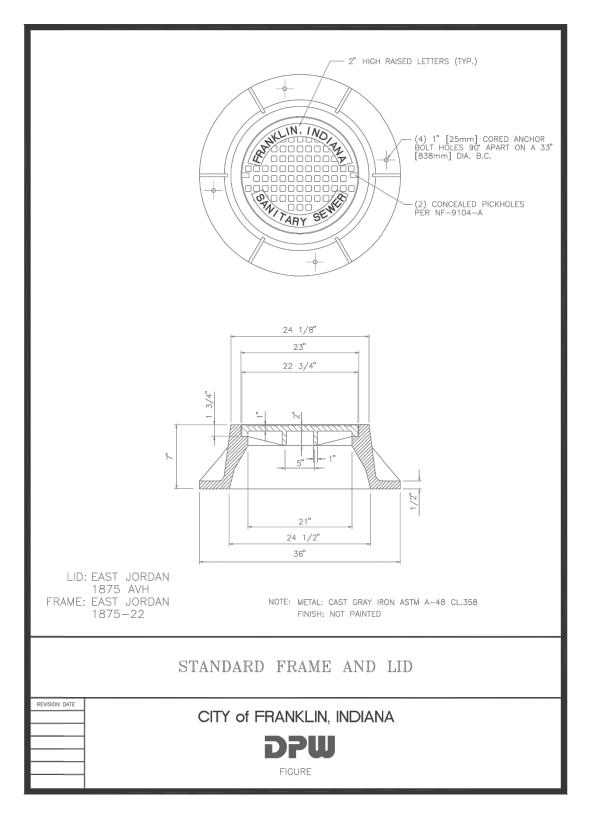



3755 Boettler Oaks Drive Suite G Uniontown, Ohio 44685 (234) 294-6340

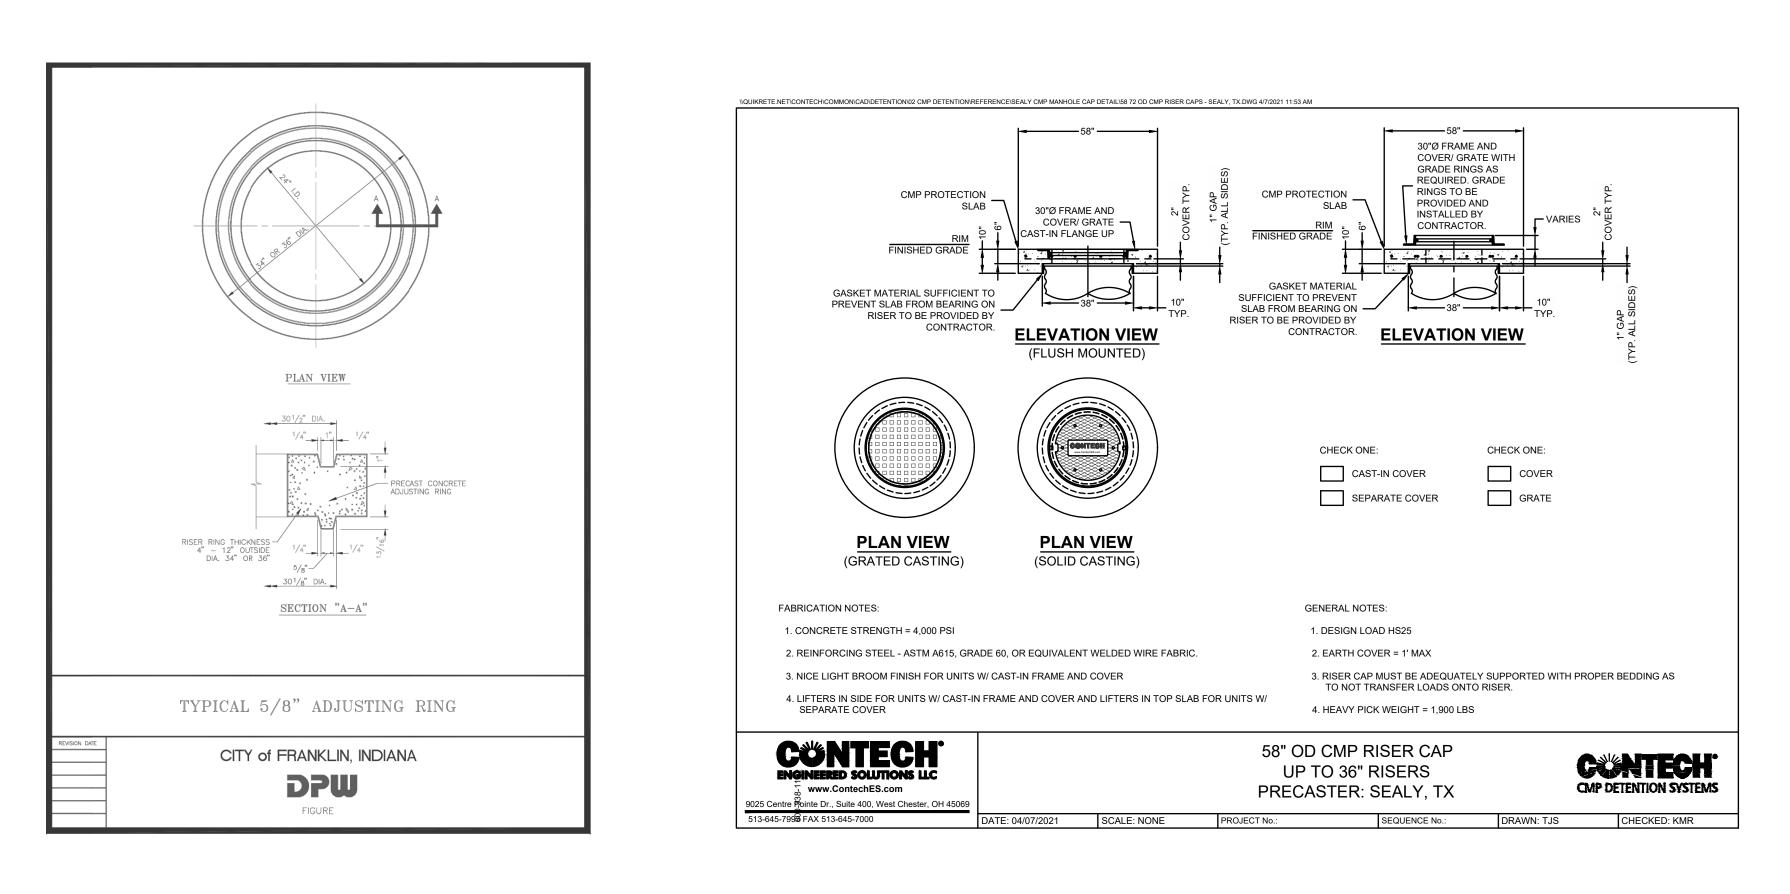UTH Ο - Sc S5 SE Z 9 AHA HA \triangleleft IDN ROVEMENTS FC RCE BUILDINGS 120 JIM BLACK ROAE JOHNSON COUNTY IMPR(\sim AKLIN, PLAN COM SIT H.F.T. Designed H.F.T. Drawn A.J.B. Reviewed AS SHOWN Scale Project No. 2100696 Date 09/08/2021 CAD File: DN210069601 SITE DETAILS Sheet No. DN-8 No.42 of 44
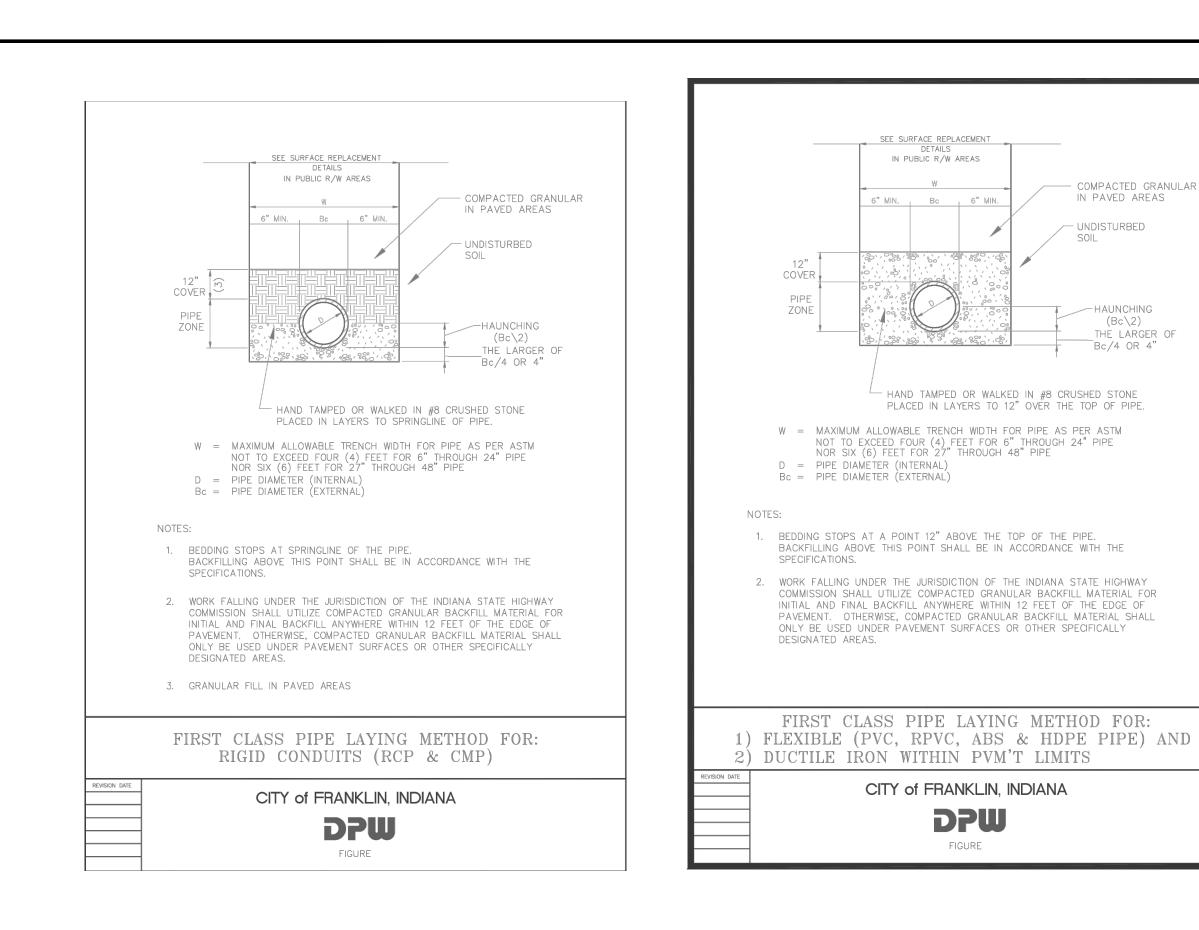
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NDTES:

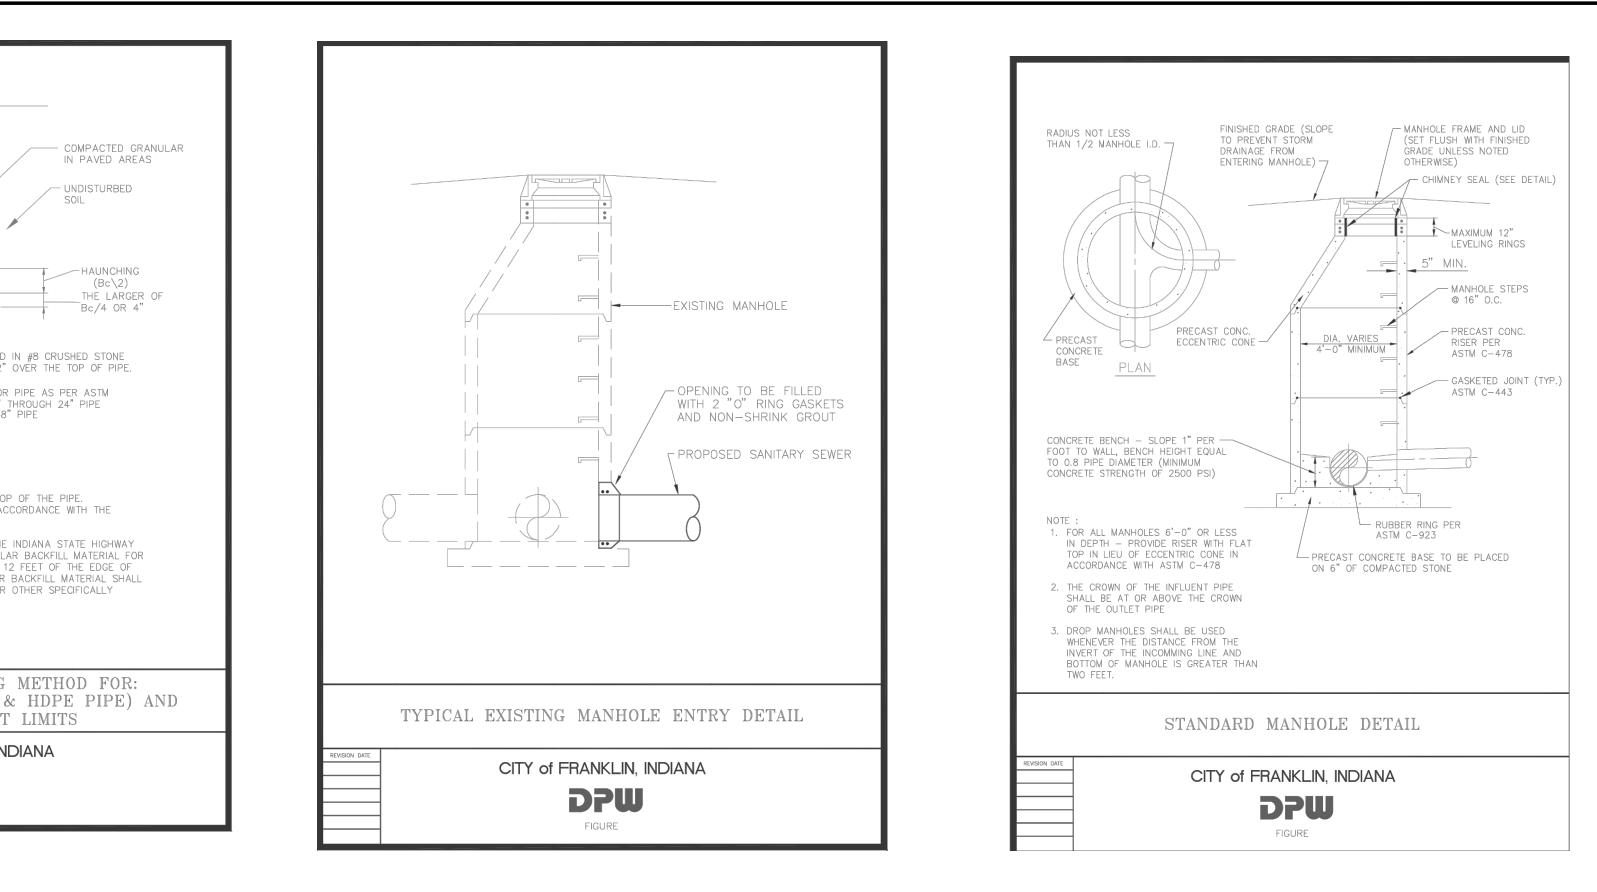EXTEND CONCRETE ENCASEMENT OF CONDUIT 10 FEET BEYOND THE CROSSING FACILITY. CONCRETE ENCASEMENT SECTION

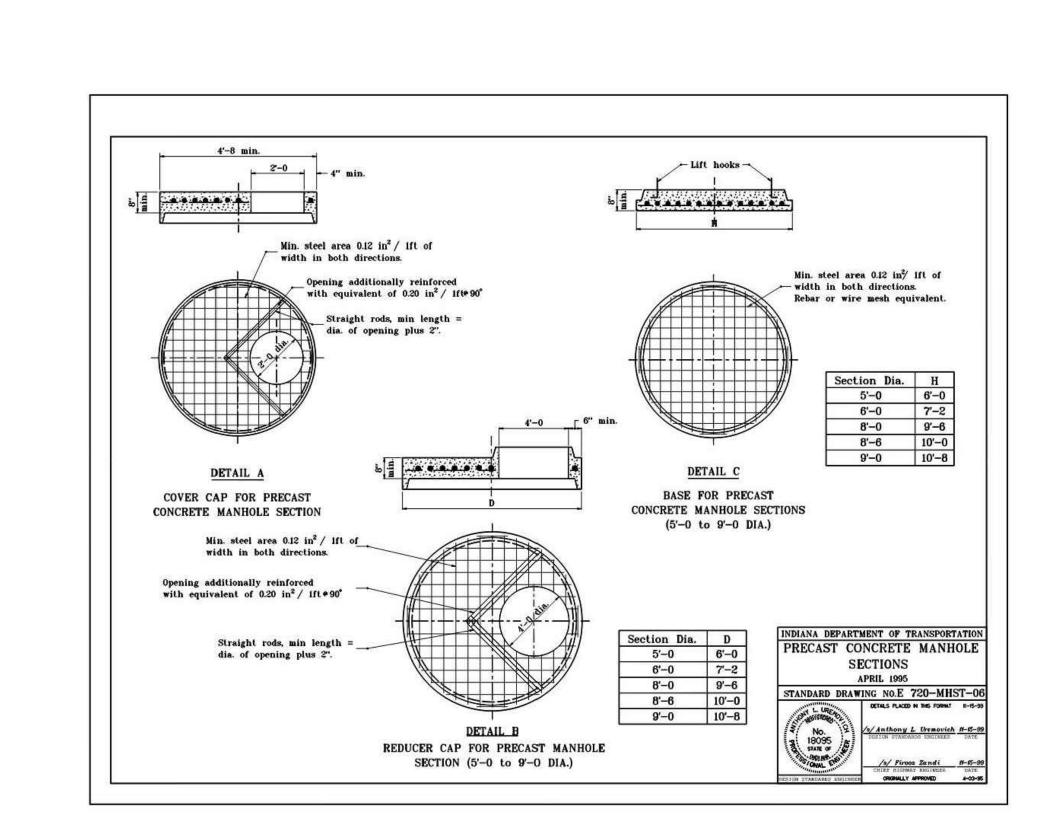N.T.S

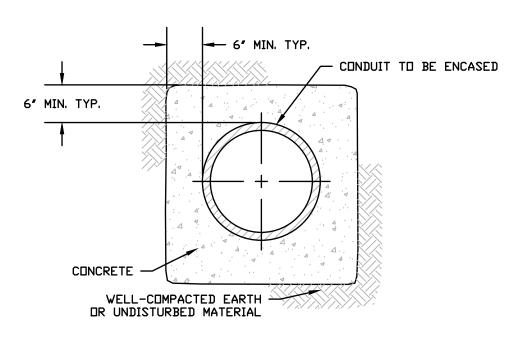