

# CRAIG WELLS CARRIAGE HOUSE

248 EAST MADISON ST FRANKLIN, IN 46131

REVIEW - 25 APR 2020



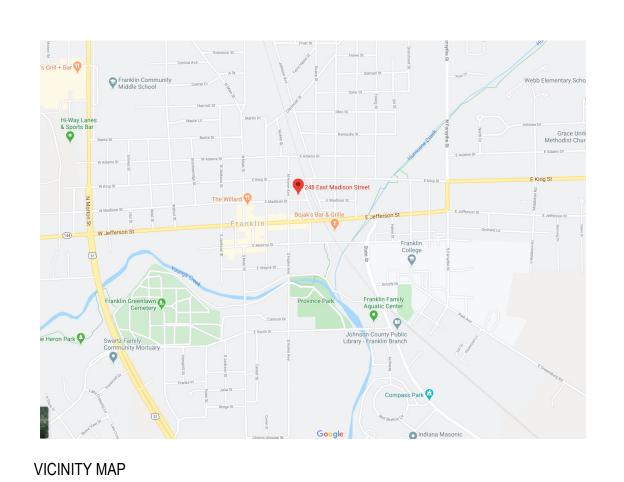

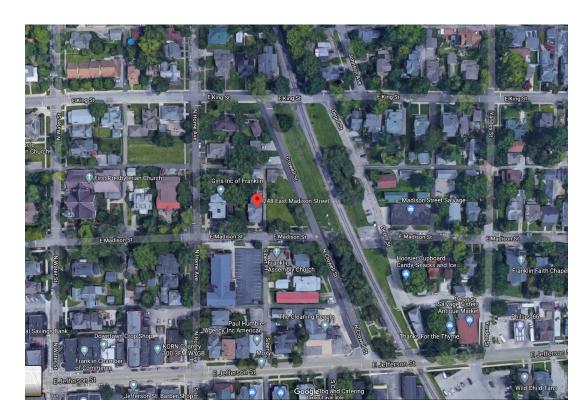

LOCATION MAP

SUMMARY OF WORK

NEW GARAGE WITH APARTMENT ABOVE ON A VACANT LOT.

# SHEET LIST

G-000 COVER

G101 GENERAL NOTES & MATERIAL REFERENCE

A100 FOUNDATION & FRAMING PLANS

A101 FIRST, SECOND & ROOF PLANS
A301 EXTERIOR ELEVATIONS

A401 BUILDING SECTIONS

A410 WALL & STAIR SECTIONS

JEFFREY COWSERT, ARCHITECT 831 N PARK AVE - APT A INDIANAPOLIS, INDIANA 46202 T: 317-407-2247

JEFFREYCOWSERT@GMAIL.COM

	ROOM FINISH SCHEDULE											
ROOM			FINISH			WALL FINISH				COUNTER	CEILING	
NUMBER	R NAME Area		FLOOR FINISH	BASE FINISH	EAST	NORTH	SOUTH	WEST	CASEWORK FINISH	FINISH	FINISH	COMMENTS
FIRST FF	L											
101	ENTERTAINMENT/LIVING CENTER	718 SF										
102	TENNANT GARAGE	309 SF										
103	FITNESS ROOM	229 SF										
104	STAIRS	95 SF										
105	MEP/CL	34 SF										
SECOND	SECOND FFL										•	
201	FOYER	89 SF										
202	DINING ROOM	109 SF										
203	KITCHEN	141 SF										
204	LAUNDRY	14 SF										
205	CLOSET	34 SF										
206	ROOM	18 SF										
207	BEDROOM	166 SF										
208	BATHROOM	50 SF										
209	CLOSET	18 SF										
210	LIVING ROOM	333 SF										
211	CLOSET	19 SF										
212	BATHROOM	71 SF										

204 SF

213 BEDROOM

214 ROOM

215 CLOSET

DOOR SCHEDULE							
MARK	DO	OR	FIRE	COMMENTS			
IVIZUAL	WIDTH	HEIGHT	RATINE	COMMENTS			
101A	3' - 0"	6' - 8"					
101B	10' - 0"	8' - 0"					
101C	10' - 0"	8' - 0"					
102A	10' - 0"	8' - 0"					
102B	3' - 0"	6' - 8"					
103A	8' - 0"	8' - 0"					
103B	3' - 0"	6' - 8"					
104	3' - 0"	6' - 8"					
105	5' - 0"	7' - 0"					
201	3' - 0"	6' - 8"					
204	2' - 10"	6' - 8"					
205	5' - 0"	7' - 0"					
206	3' - 0"	6' - 8"					
207	3' - 0"	6' - 8"					
208	3' - 0"	6' - 8"					
209	2' - 6"	6' - 8"					
211	2' - 6"	6' - 8"					
212A	2' - 8"	6' - 8"					
212B	2' - 4"	6' - 8"					
213	2' - 8"	6' - 8"					
214	1' - 6"	6' - 8"					
215	3' - 0"	6' - 8"					

WINDOW SCHEDULE - SIZES VARY BY MANUFACTURER							
		WINDOW					
TYPE MARK	WIDTH	HEIGHT	HEAD HEIGHT	COMMENTS			
Α	3' - 2"	5' - 1"	8' - 0"	1			
Α	3' - 2"	5' - 1"	8' - 0"	1			
Α	3' - 2"	5' - 1"	8' - 0"	1			
Α	3' - 2"	5' - 1"	6' - 8"	1			
Α	3' - 2"	5' - 1"	6' - 8"	1			
Α	3' - 2"	5' - 1"	6' - 8"	1			
Α	3' - 2"	5' - 1"	6' - 8"	1			
Α	3' - 2"	5' - 1"	6' - 8"	1			
Α	3' - 2"	5' - 1"	6' - 8"	1			
Α	3' - 2"	5' - 1"	6' - 8"	1			
Α	3' - 2"	5' - 1"	6' - 8"	1			
В	2' - 0"	2' - 0"	7' - 8"				
В	2' - 0"	2' - 0"	7' - 8"				
В	2' - 0"	2' - 0"	7' - 8"				
В	2' - 0"	2' - 0"	7' - 8"				
В	2' - 0"	2' - 0"	6' - 8"				
С	3' - 0"	3' - 0"	6' - 8"				
D	3' - 0"	5' - 1"	6' - 8"	1			
D	3' - 0"	5' - 1"	6' - 8"	1			
D	3' - 0"	5' - 1"	6' - 8"	1			
D	3' - 0"	5' - 1"	6' - 8"	1			
Е	2' - 0"		9' - 6"	2			

# WINDOW COMMENTS

- 1. WINDOW MEETS THE EGRESS CRITERIA OF MINIMUM 20" NET OPENING WIDTH, MINIMUM 24" NET OPENING
- HEIGHT, AND MINIMUM 5.7 S.F. OPENING AREA. 2. 24" DIAMETER FIXED WINDOW.

### **GENERAL ROOF PLAN NOTES**

WEATHER LIMITATIONS: PROCEED WITH INSTALLATION ONLY WHEN EXISTING AND FORECASTED WEATHER CONDITIONS PERMIT ROOFING SYSTEM TO BE INSTALLED ACCORDING TO MANUFACTURER'S WRITTEN INSTRUCTIONS AND WARRANTY REQUIREMENTS.

- A. COORDINATE INSTALLING ROOFING SYSTEM COMPONENTS SO INSULATION IS NOT EXPOSED TO PRECIPITATION OR LEFT EXPOSED AT THE END OF THE WORKDAY.
- B. COMPLY WITH ROOFING SYSTEM AND INSULATION MANUFACTURER'S WRITTEN INSTRUCTIONS FOR INSTALLING ROOF INSULATION.
- C. FINAL ROOF INSPECTION: ARRANGE FOR ROOFING SYSTEM MANUFACTURER'S

TECHNICAL PERSONNEL TO INSPECT ROOFING INSTALLATION ON COMPLETION.

#### GENERAL FLOOR PLAN NOTES

THE FOLLOWING GENERAL NOTES ARE APPLICABLE THROUGHOUT THESE CONSTRUCTION DRAWINGS.

- A. NOTHING SET FORTH IN THESE DRAWINGS SHALL RELEASE THE CONTRACTOR FROM ITS RESPONSIBILITY TO PROVIDE APPROPRIATE QUANTITIES, FIELD MEASUREMENTS, DIMENSIONAL STABILITY, INSTALLATION, ANCHORAGE, AND COORDINATION WITH ITS SUBCONTRACTORS AND TRADES. OR RELEASE THE CONTRACTOR OF RESPONSIBILITY TO IDENTIFY AND RESOLVE DEVIATIONS FROM THE REQUIREMENTS OF THESE DOCUMENTS, OR RELEASE THE CONTRACTOR OF RESPONSIBILITY TO ALERT THE ARCHITECT TO ERRORS OR OMISSIONS CONTAINED THEREIN.
- B. THE CONTRACTOR AND ALL ITS SUBCONTRACTORS SHALL VERIFY IN THE FIELD ALL NEW AND EXISTING APPLICABLE CONDITIONS, DIMENSIONS, RELATIONSHIPS, ETC. SHOWN IN THESE DRAWINGS AND AS PERTINENT TO THE INTENT OF THESE DRAWINGS. ANY DISCREPANCY DISCOVERED SHALL BE BROUGHT TO THE ATTENTION OF THE ARCHITECT PRIOR TO THE COMMENCEMENT OF ANY WORK AFFECTED BY, OR RELATED TO, SUCH DISCREPANCY. THE CONTRACTOR SHALL BE RESPONSIBLE FOR ALL COSTS ASSOCIATED
- WITH, OR CAUSED BY, ITS FAILURE TO COMPLY WITH THIS REQUIREMENT. C. ALL FLOOR PLAN DIMENSIONS SHOWN ON THE NEW FLOOR PLANS ARE FROM FACE OF STUD UNLESS INDICATED OTHERWISE BY THE DESIGNATIONS "CLR", "CLEAR", OR "MIN." COORDINATE WITH APPLICABLE NEW WALL TYPES AND WITH APPLICABLE
- SECTIONS/DETAILS.
- COMPLIANCE WITH 2018 INTERNATIONAL RESIDENTIAL CODE (IIRC) WITH INDIANA AMENDMENTS, APPLICABLE LOCAL LAWS, CODES, ORDINANCES, AND STANDARDS.
- B. ALL WORK CONTRACTED OR SUBCONTRACTED FOR THE COMPLETION OF THIS

DRAWINGS.

LUMBER SUPPLIER. B. ALL STUDS TO BE 2x4's @ 16" O.C.

# GENERAL PROJECT ABBREVIATIONS

ANCHOR BOLT ACOUSTIC CEILING TILE AREA DRAIN ABOVE FINISHED FLOOR ARCHITECT JEFFREY COWSERT, ARCHITECT AIR HANDLING UNIT ALUMINUM ANODIZED

ANOD BD BOARD BLDG BUILDING BTM BOTTOM BRG BEARING CIP CAST IN PLACE CONTROL JOINT CENTER LINE

ACT

AFF

ALUM

CLG CEILING CLEAR CLR CMU CONCRETE MASONRY UNIT COL COLUMN CONC CONCRETE

CONT CONTINUOUS CPT CARPET CONTRACTOR FURNISHED, CONTRACTOR INSTALLED CRFCRI

CERAMIC TILE D DBL DRYER DOUBLE

FIRE EXTINGUISHER CABINET

FIBERGLAS REINFORCED PLASTIC

GROSS SQUARE FOOTAGE

GYPSUM WALL BOARD

FIRE HOSE CABINET

FLOOR

FILLED METAL FOUNDATION

FOOT/FEET GAUGE

GALVANIZED GYPSUM BOARD

GLASS

GRANITE

HOSE BIB

HOLLOW CORE HOLLOW METAL HIGH POINT

FINISHED FLOOR LEVEL

DEMO DEMOLISH OR DEMOLITION DIA DIAMETER DIMENSION DN DOWN DR DOOR

DISHWASHER

DRAWING

EACH EA **EXPANSION JOINT** EJ ETHYLENE PROPYLENE DIENE M-CLASS (ROOFING) **EQUAL** 

FHC

FFL

GALV

GB

GL

GR

GSF

HB

HC

HR

HVAC

GWB

FLR

EQ EX **EXISTING** EXT EXTERIOR FCL FINISHED CEILING LEVEL FD FLOOR DRAIN FIRE EXTINGUISHER

D. AT ALL WALLS SCHEDULED TO RECEIVE CERAMIC TILE, PROVIDE CEMENT BACKER BOARD

# PROJECT GENERAL NOTES:

- A. GENERAL CONTRACTOR IS RESPONSIBLE FOR ALL WORK COMPLETED IN
- PROJECT IS SUBJECT TO REVIEW AND FINAL APPROVAL BY THE OWNER. C. ALL CHANGES SHALL BE APPROVED BY OWNER PRIOR TO PROCEEDING WITH THE

## STRUCTURAL NOTES

THE FOLLOWING GENERAL NOTES ARE APPLICABLE THROUGHOUT THESE CONSTRUCTION

A. ALL WOOD BEAMS, FLOOR JOISTS, CEILING JOISTS AND RAFTERS TO BE SIZED BY THE

C. SILL PLATES SHALL BE 2x8 PRESSURE TREATED. D. PRESSURE TREAT ANY WOOD WITHIN 8" OF CONTACT WITH EARTH / FINISHED

CERTIFICATION:

DRAWN BY:

MATERIAL

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S

SENERAL NOTES

<u>6</u>

CRAIG WELLS - CW( CARRIAGE HOUSE

CHECKED BY:

HOUR HEATING, VENTILATING, AND AIR CONDITIONING INSIDE DIAMETER

IN LIEU OF INCH/INCHES

INTERIOR INSUL INSULATED OR INSULATION IMPACT RESISTANT GYPSUM WALL BOARD **IRGWB** JANITOR'S CLOSET

MAXIMUM MECH MECHANICAL MEMBR -MEMBRANE MINIMUM OR MINUTE

MASONRY OPENING MOISTURE-RESISTANT GYPSUM WALL BOARD MRGWB MTL METAL NOT APPLICABLE

N/A NOT IN CONTRACT NTS NOT TO SCALE oc ON CENTER OD OUTSIDE DIAMETER

OWNER FURNISHED. CONTRACTOR INSTALLED OFCRI OWNER FURNISHED, OWNER INSTALLED OFOI ORIENTED STRAND BOARD OSB

PRE-CAST CONCRETE PLASTIC LAMINATE PLUMB PLUMBING PLYD PLYWOOD PAINT OR PAINTED PTR PRESSURE TREATED POLYVINYL CHLORIDE

RISER RBR RUBBER RBRB RUBBER BASE REFLECTED CEILING PLAN RCP RD **ROOF DRAIN** RE REFER TO

REFERENCE REFRIGERATOR REFR REQ'D REQUIRED RM ROOM RO ROUGH OPENING SOLID CORE SCONC -SEALED CONCRETE SMOKE DETECTOR

SIM SIMILAR SP SPRINKLER SPECIFICATION SPEC SPEAKER STAINLESS STEEL - SOUND TRANSMISSION COEFFICIENT

STC STL - STEEL STRUCT - STRUCTURE OR STRUCTURAL

SQUARE FOOT, FEET

TREAD TONGUE AND GROOVE TELEPHONE/DATA TELE TELEPHONE TLT - TOILET

TO MATCH EXISTING TOP OF TOP OF CONCRETE TOP OF STEEL T/W TOP OF WALL TR TREATED TYP


TYPICAL UNDERSIDE UNLESS NOTED OTHERWISE

UNO VERIFY IN FIELD VIF VINYL COMPOSITION TILE VT VINYL TILE WASHER

WITH WITHOUT W/O WATER CLOSET WOOD WATER HEATER WELDED WIRE FABRIC WWF

U/S

**REVIEW** 25 APR 2020

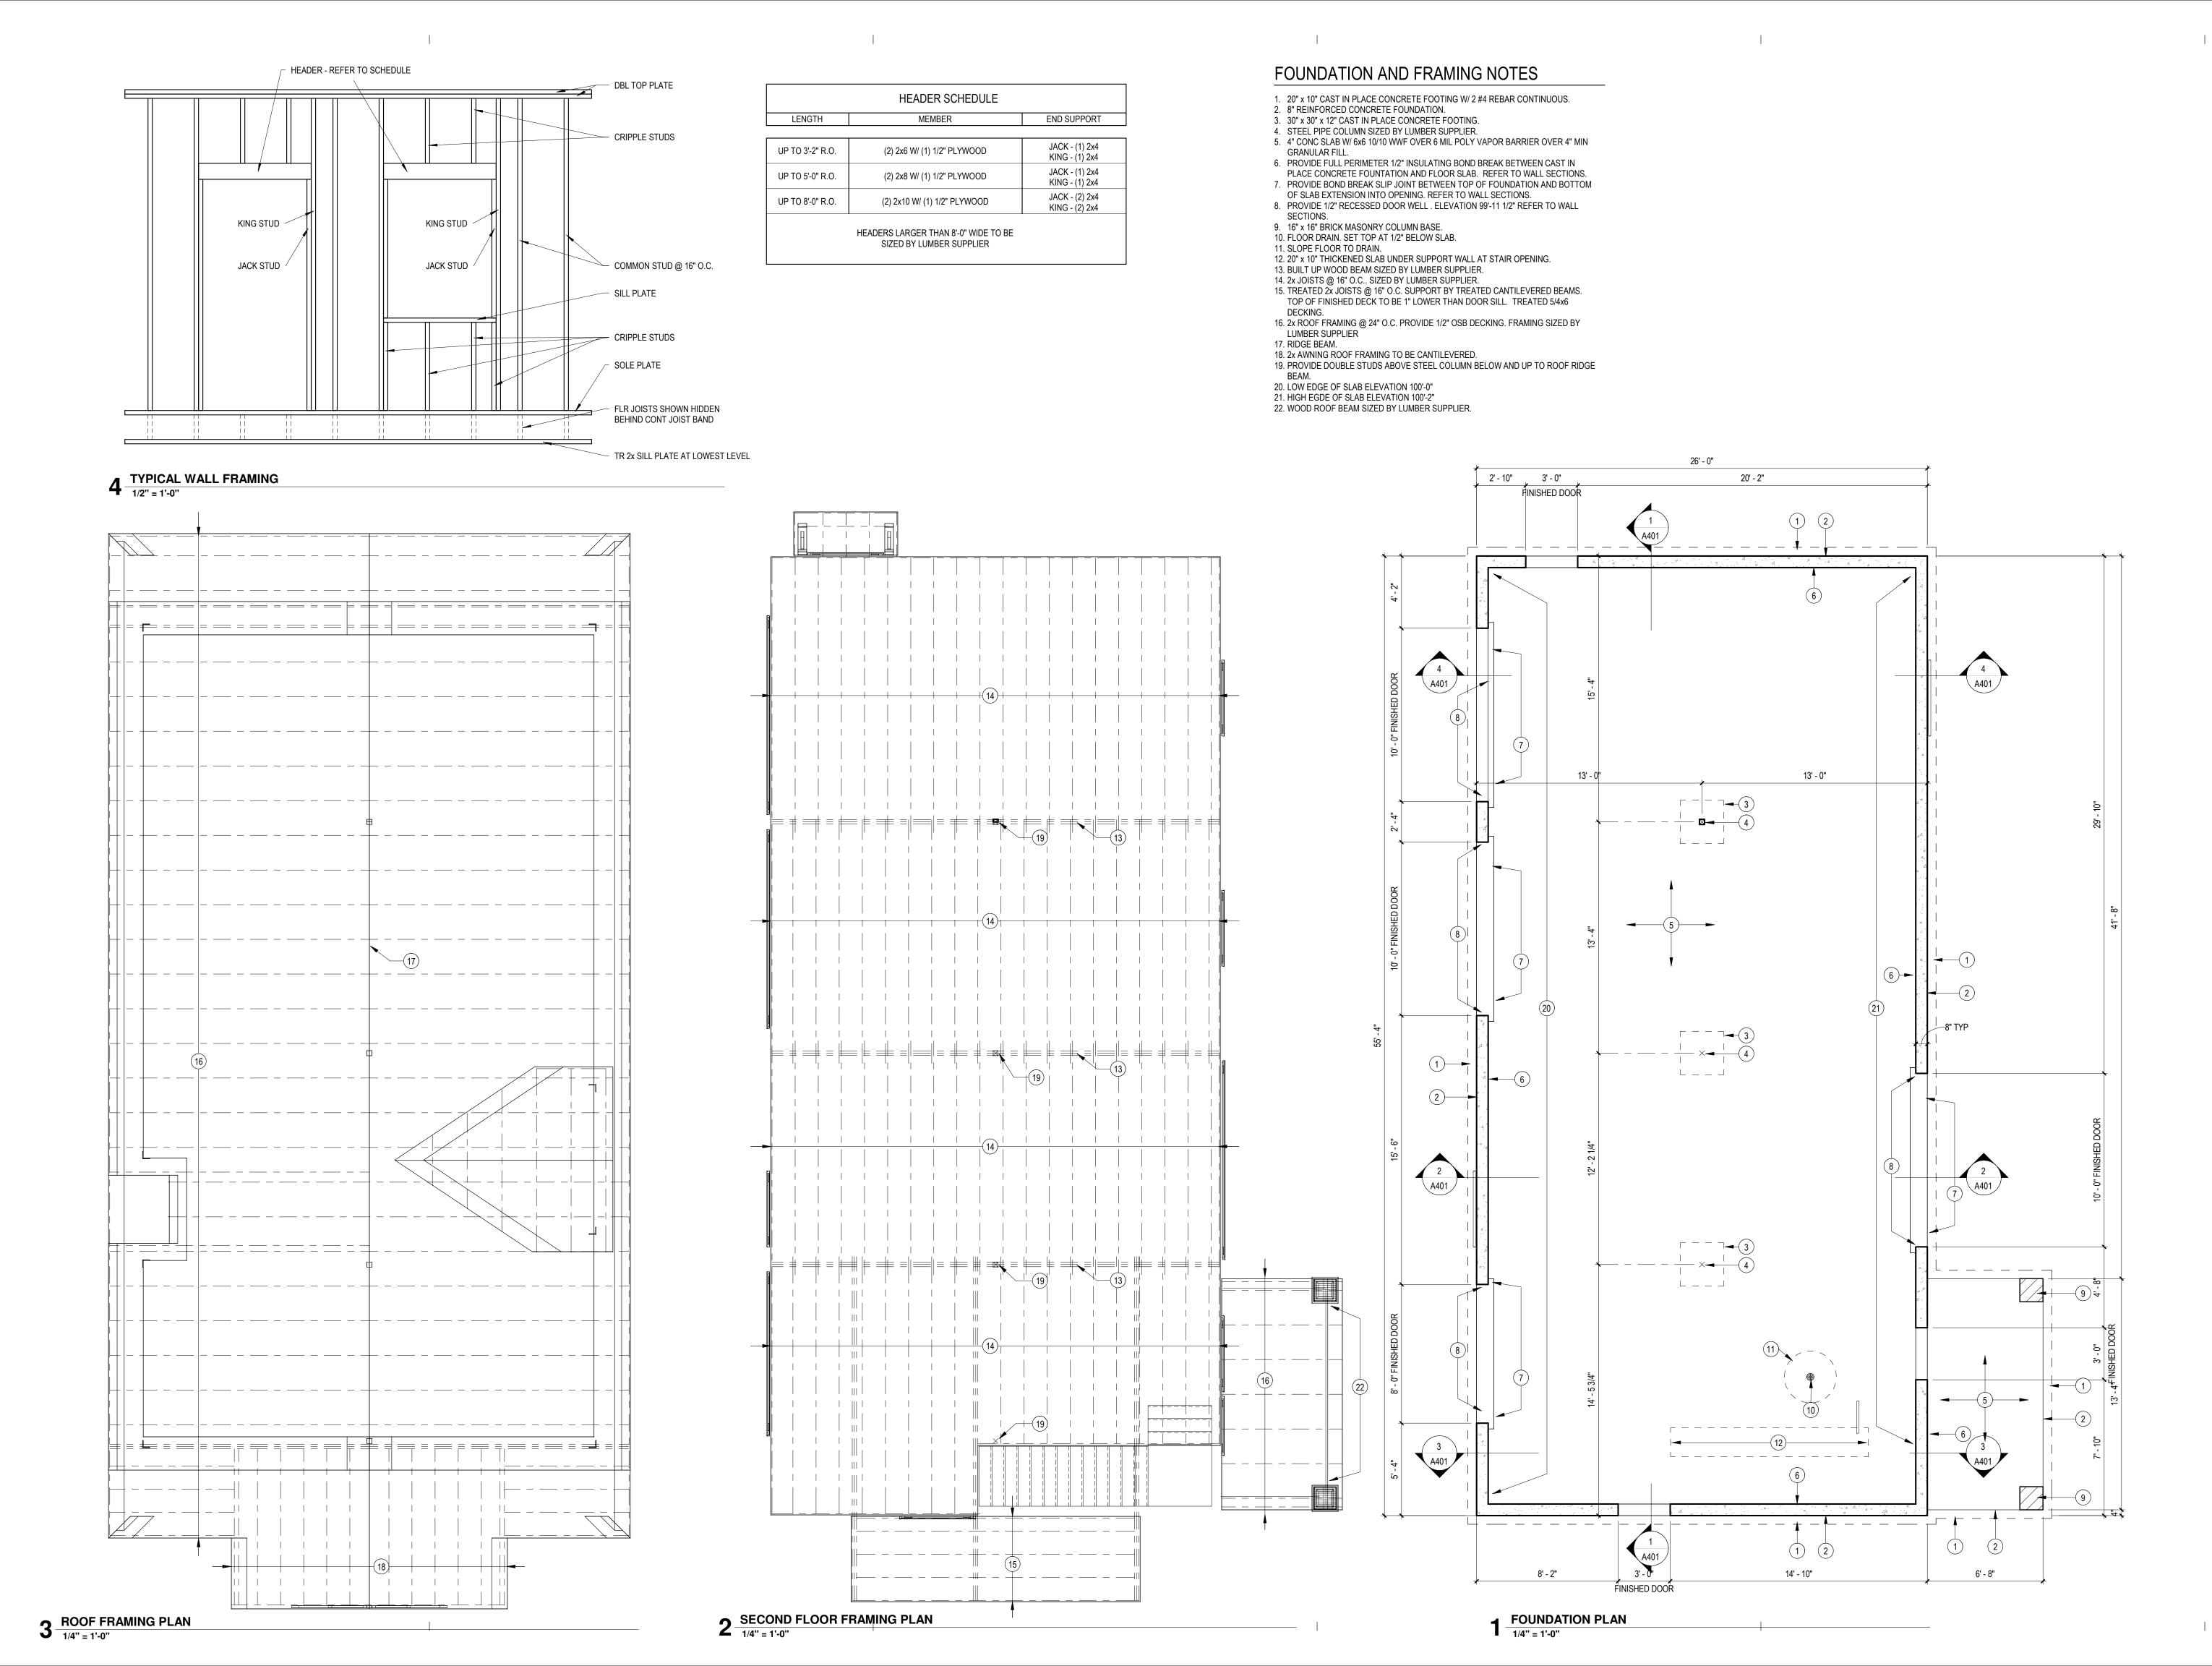


ARCHITECT
JEFFREY COWSERT, ARCHITECT

CERTIFICATION:

CHECKED BY:

**FOUNDATION** 

**REVIEW** 

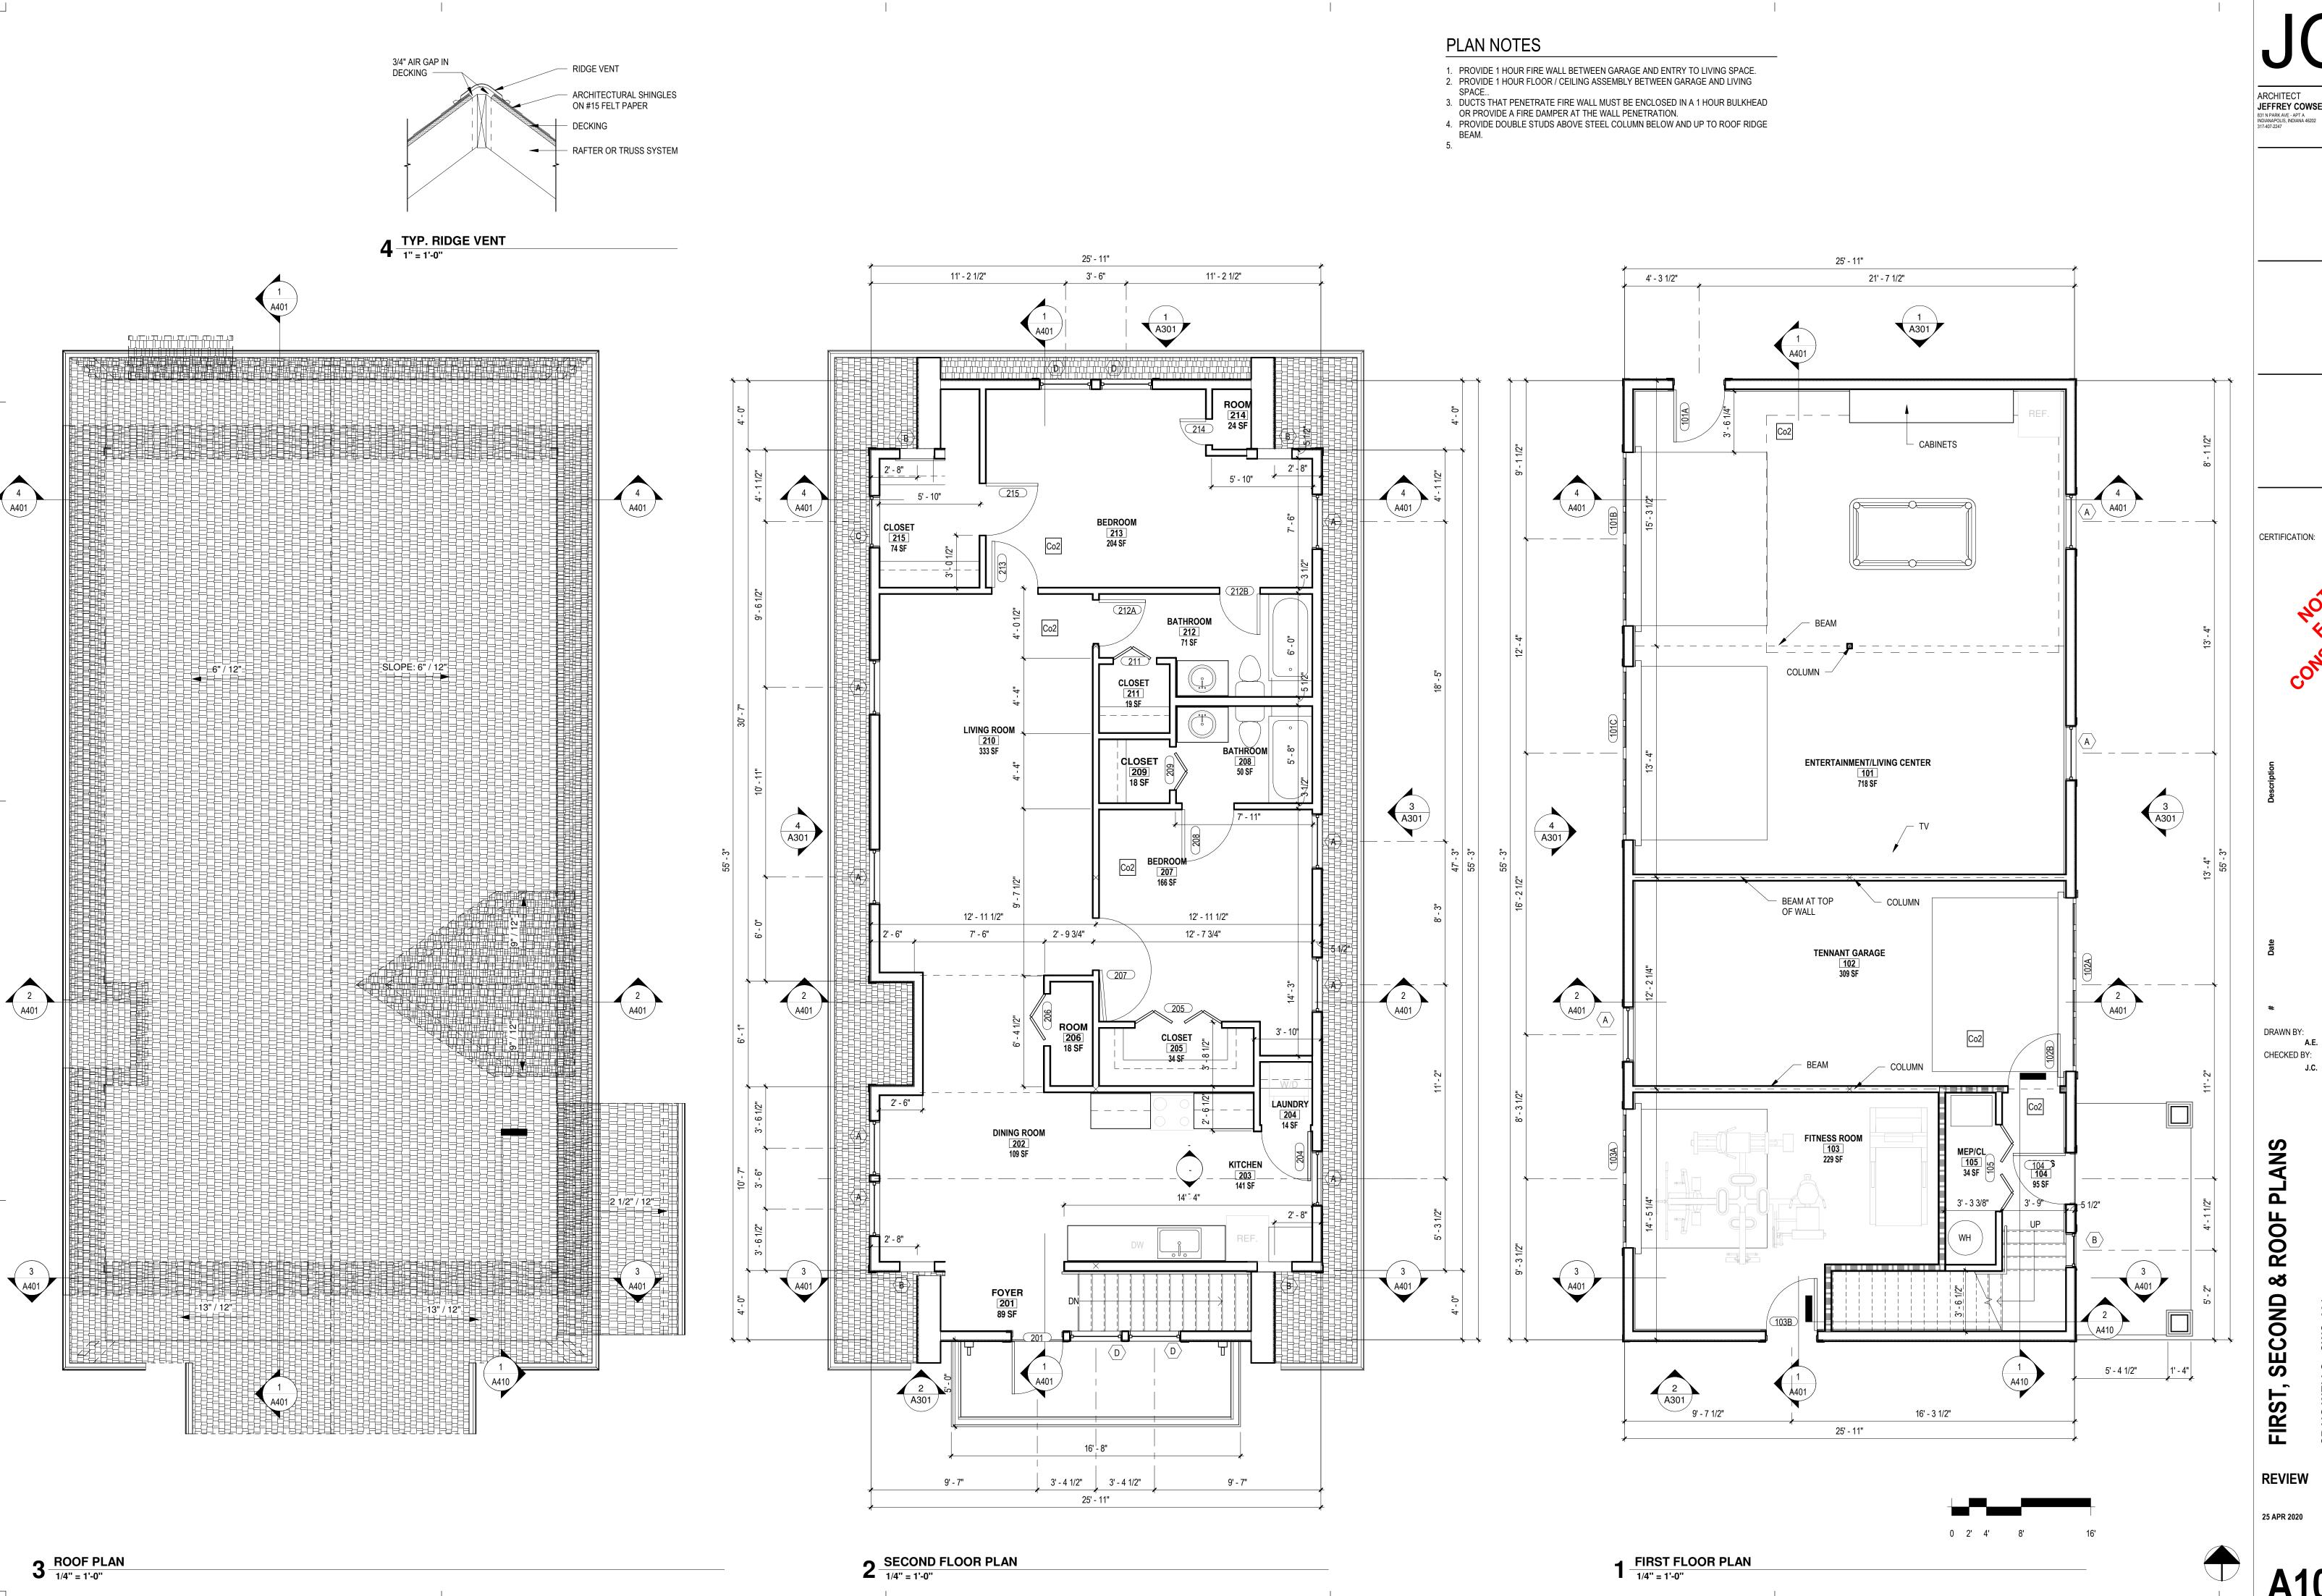

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CHECKED BY:

**REVIEW** 





6' - 0"


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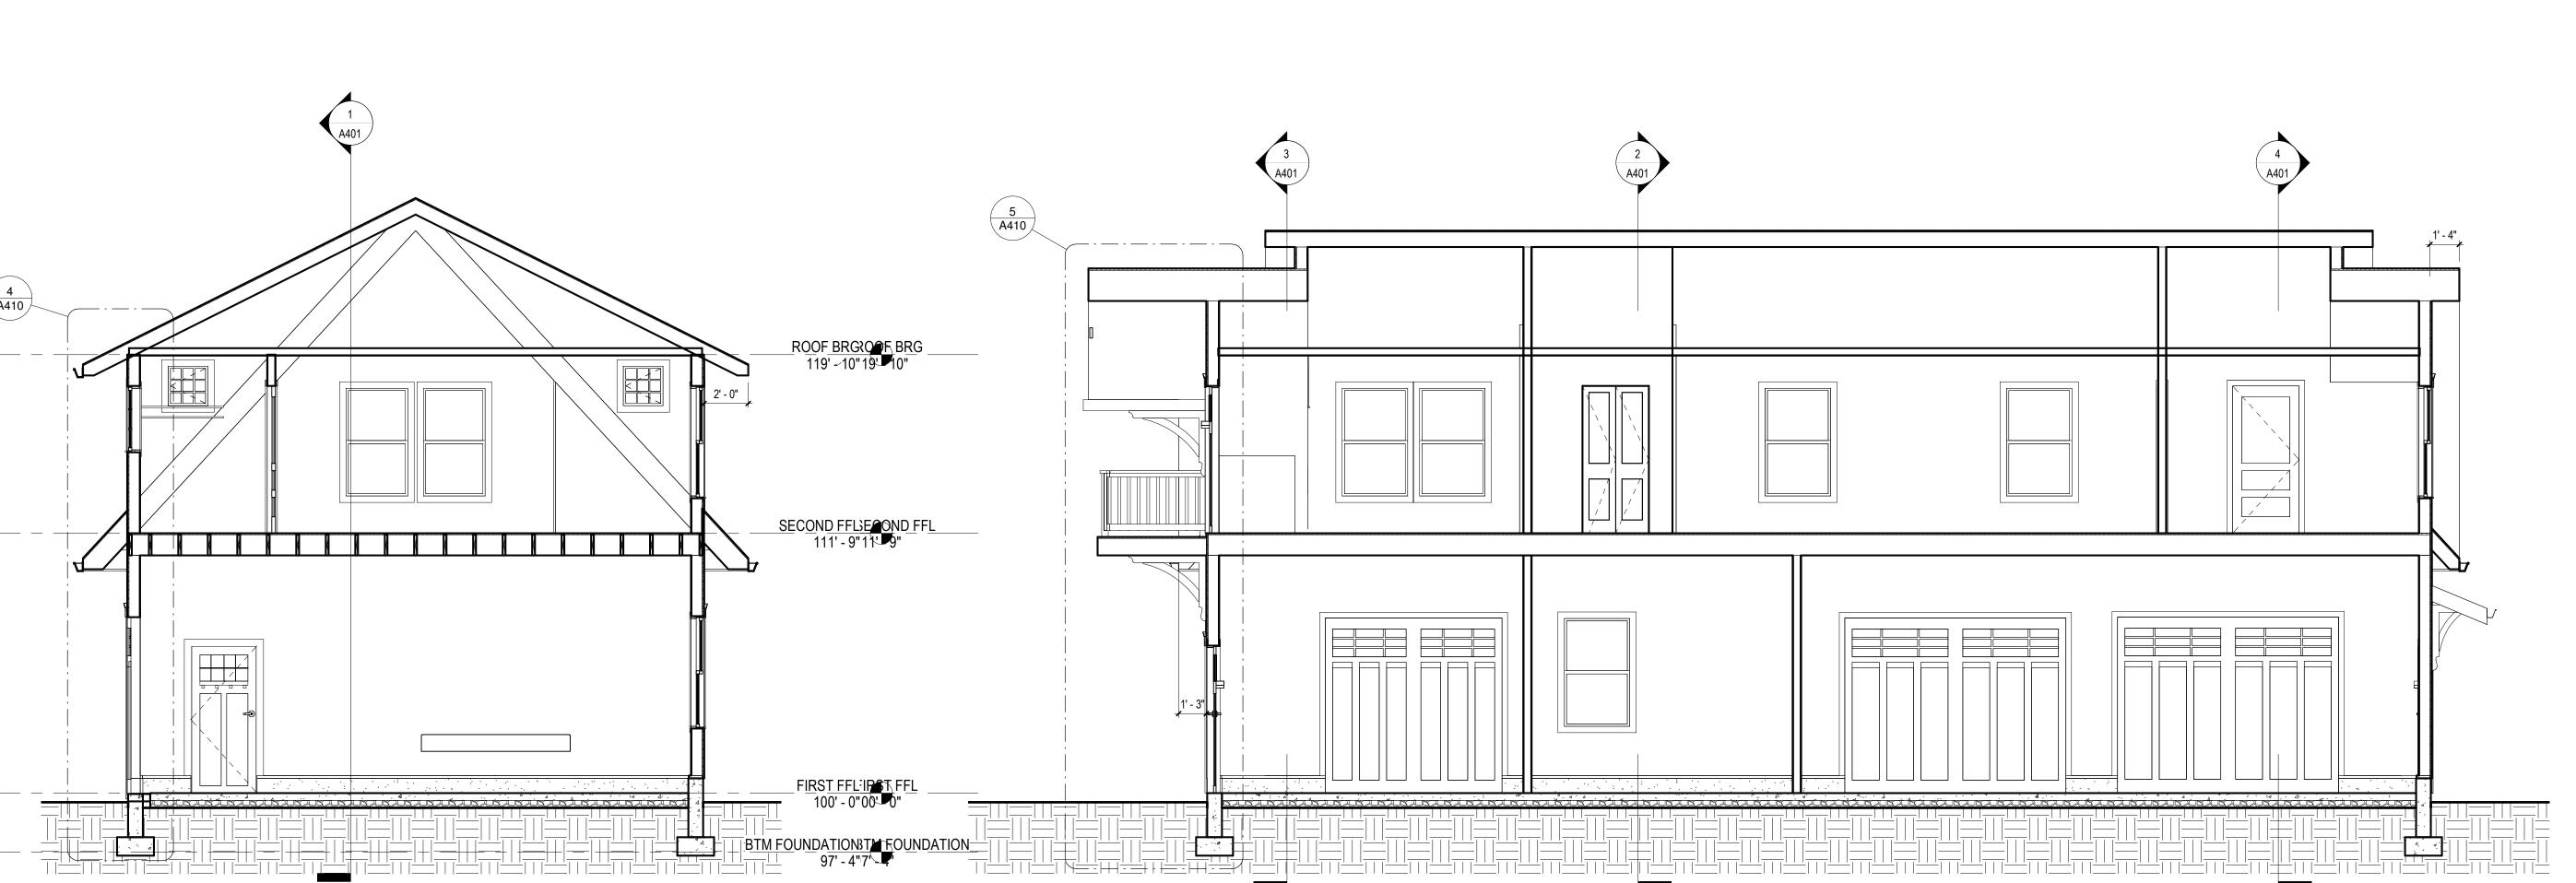
ROOF BRG 119' - 10" CERTIFICATION: SECOND FFL 111' - 9"

**EXTERIOR ELEVATIONS** 

SECOND FFL 111' - 9"

**REVIEW** 



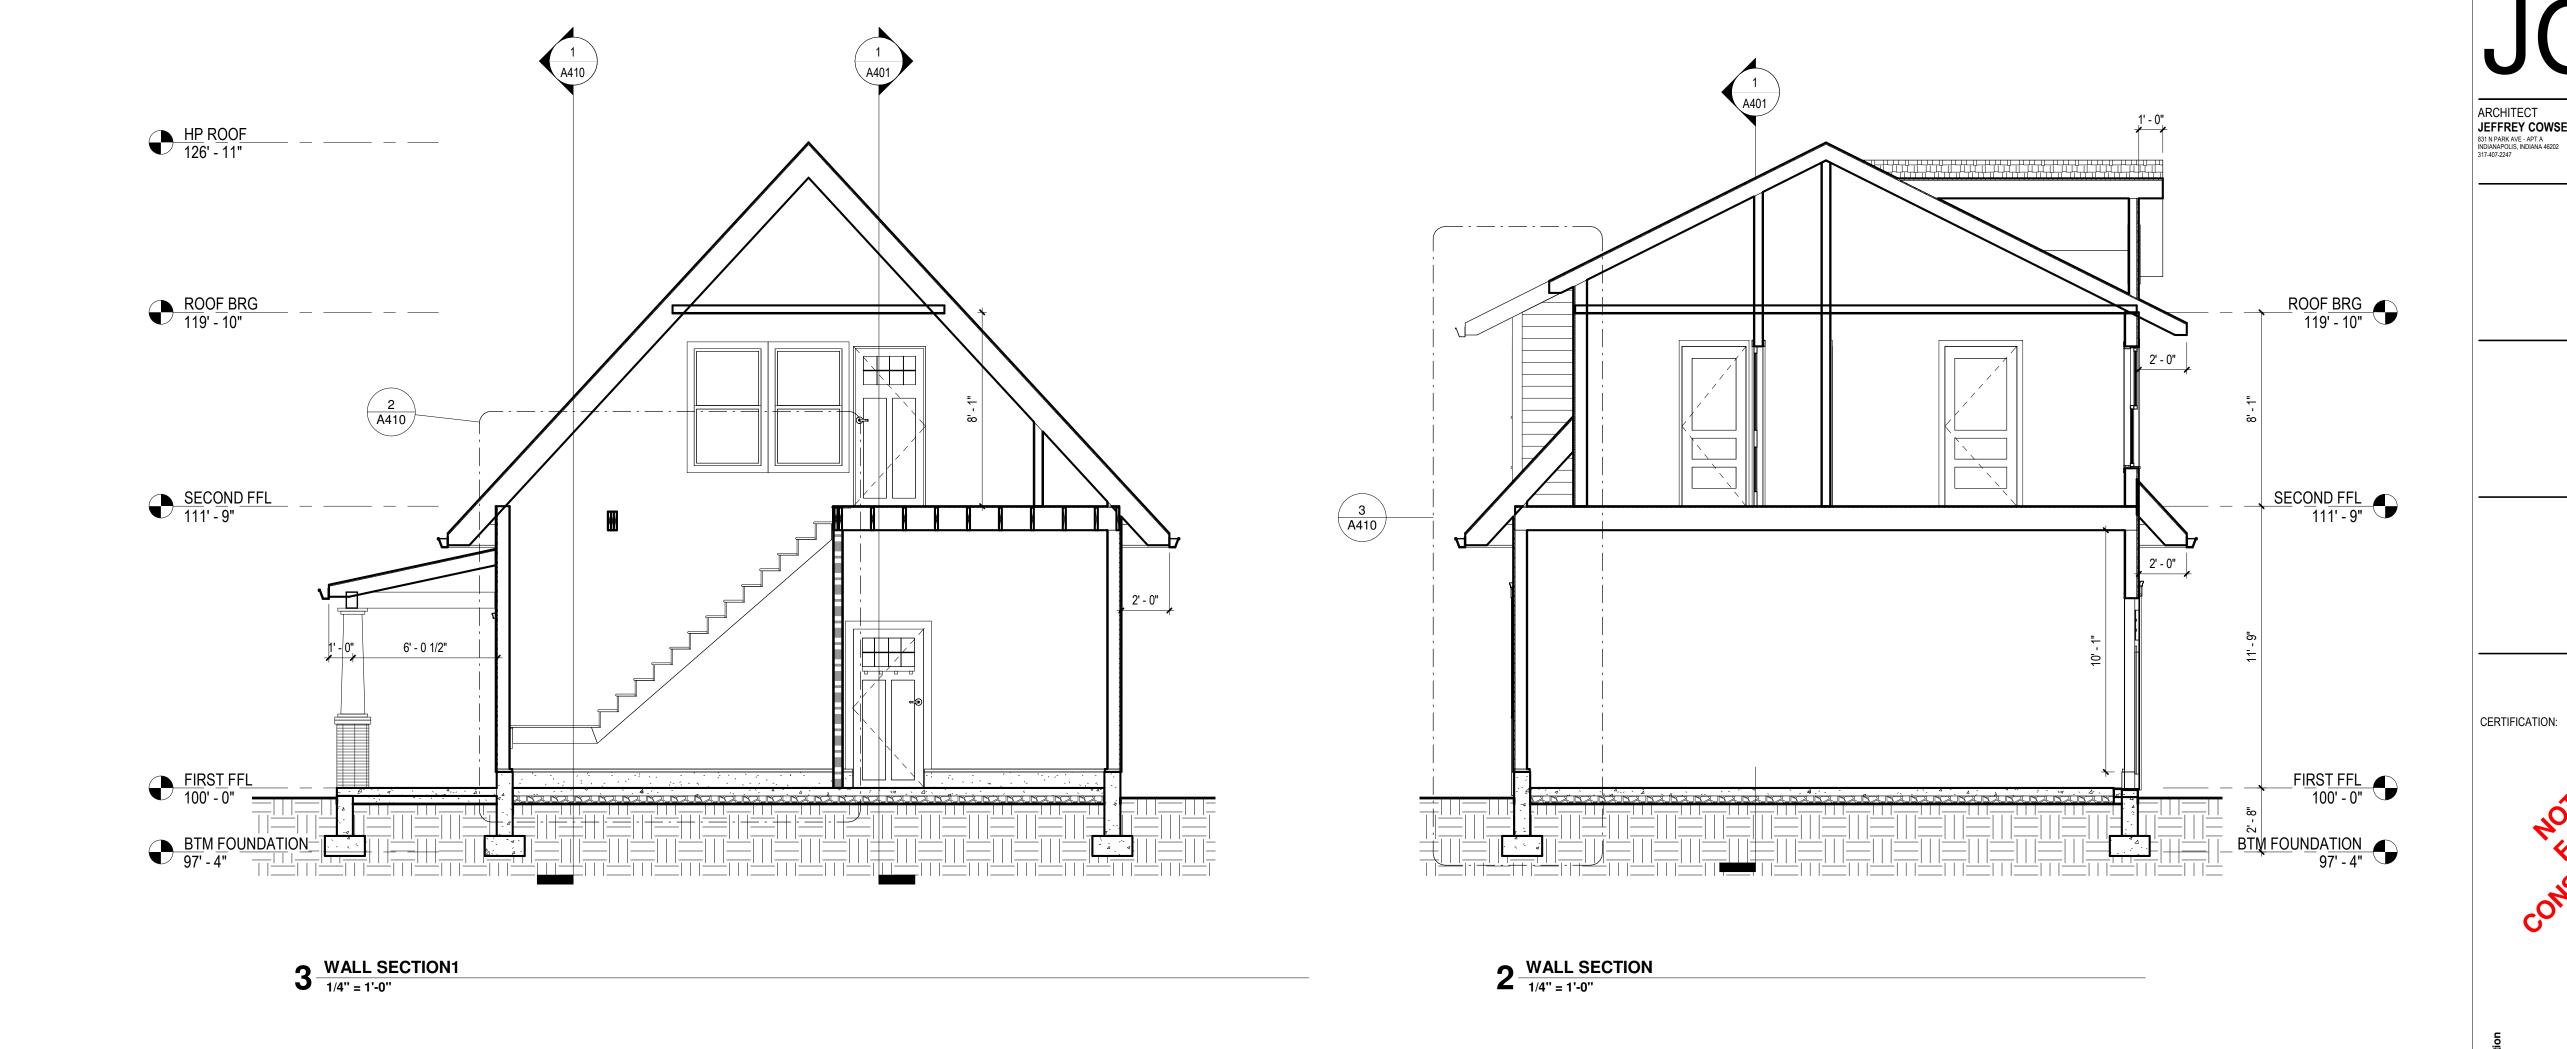

ARCHITECT
JEFFREY COWSERT, ARCHITECT
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INDIANAPOLIS, INDIANA 46202
317-407-2247

DRAWN BY:

CHECKED BY:

**BUILDING SECTIONS** 

**REVIEW** 

25 APR 2020

**4** WALL SECTION2

1/4" = 1'-0"

